GUILDFORD POOL MODERNISATION PROJECT

This project is located on Darug Country

CUMBERLAND CITY COUNCIL LOT 21, DP 1018330, 1 TAMPLIN ROAD, GUILDFORD





SYDNEY

Gadigal Country

Level 5, 111-117 Devonshire St

Surry Hills NSW 2010

T +61 2 8396 9500 syd@modedesign.com.au STATUS: DEVELOPMENT APPLICATION

ISSUE DATE: 03/07/2024

PROJECT No: 23710

SYMBOLOGY

BUILDING ELEMENTS DOORS AND WINDOWS D DOOR 0.00a NUMBER W WINDOW NUMBER CEILINGS C.XX-00 CEILING TYPE 3600 HEIGHT ABOVE LEVEL OTHER BUILDING ELEMENTS Z.ZZ-00a REFER CODING SYSTEM MATERIALS/ FINISHES

REVISION REVISION REVISION CLOUD REVISION NUMBER 22 DESCRIPTION REVISION DESCRIPTION SETOUT

MMqq01 REFER CODING SYSTEM

DRAWING SCALE


GRID HEAD LEVEL SLOPE STEP REFERENCING

PLAN TITLE DRAWING TITLE VIEW NUMBER -Scale: 1:100 7 A202 REFERENCE DRAWING SCALE SHEET **ELEVATION/ SECTION TITLE** DRAWING TITLE VIEW NUMBER-→ A202 Scale: 1:100

ELEVATION REFERENCE VIEW NUMBER-



SHEET

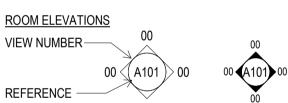

SECTION REFERENCES VIEW NUMBER-

ABBREVIATIONS LEGEND

DRAF	TING ABBREVIATIONS	
AFFL	ABOVE FINISHED FLOOR LEVEL	
ASFL	ABOVE STRUCTURAL FLOOR LEVEL	
COS	CHECK/ CONFIRM ON SITE	
EQ	EQUAL	
FFL	FINISHED FLOOR LEVEL	
NOM	NOMINAL	
NTS	NOT TO SCALE	
R##	RADIUS ##mm	
SFL	STRUCTURAL FLOOR LEVEL	
TBC	TO BE CONFIRMED	
TYP	TYPICAL	
UNO	UNLESS NOTED OTHERWISE	
Ø	DIAMETER	

* TO BE FURTHER DESIGNED DURING THE DETAIL DESIGN PHASE

CODE	ITEM /
A.GR02	GRAB RAIL: PWD/ UNIVERSAL WC
A.GR03	GRAB RAIL: SHOWER
A.R	ACCESS: RAMP
A.SP	STAIR: PRECAST.
A.SP-15	STAIR: PRECAST - 150mm
A.SS-01	SEAT: SHOWER
A.SS.02	GRAB RAIL: BACKREST
ACU	AIR-CONDITIONING COMPRESSOR/ CONDENSER UNIT
B.BR	BALUSTRADE: RAILING / L/
B.WB	WASTE: BIN (GENERAL)
COL	STRUCTURAL COLUMN / 3
D	<varies></varies>
DP	ROOF & RAINWATER: PIPE
DX	/2
E.O-01	IN-DESK POWER GROMMET
F-##	FLOOR - TYPE ##
G.ZM-AL02	COMMON ELEMENTS: MULLION (SQUARE) - ALUMINIUM, TYPE 02
G.ZM-AL04	COMMON ELEMENTS: MULLION (SQUARE) - ALUMINIUM, TYPE 04
H.DS	DRAINAGE: SHOWER
H.FW	DRAIN: special requirements
H.PB	PLUMBING: BASIN
H.PB-02	P EOIVIDING. BASIN
H.PBS	PLUMBING: BASIN: SHROUS
	PLUMBING: CUBICLE (\$HOWER TRAY/ BASE)
H.PC	TAPWARE: MIXER
H.PT-02	TAPWARE: WILLER
H.PW-01	DAINIMATED OUTTE TYPE ##
H.RG-##	RAINWATER: GUTTER TYPE ##
H.SH-02	TAPWARE: SHOWER PLEAD/ ROSE
H.TM	TAPWARE: MIXER
HOTPLATE	
I.CV	CABINET: VANTY (PROPRIETARY)
I.FC	FURNITURE EMAIR
I.FO	FURNITURE: OTTOMAN
I.FT	FURNITURE: TABLE
I.HE	HOOK: EQUIPMENT
I.PC	PARTITIONING: CURTAIN SYSTEMS
I.PS	PARTITIONING: SHOWER CURTAIN (WITH TRACK)
I.SC	SEATING: CHANGE ROOM
IDS-01	DISPENSER: SOAP
IE.01 /	
IFC.01 /	FURNITURE: CHAIR
IH.01 /	
IH.02	
IP.01	
J.B-03	JOINERY: BENCHTOP
J.CF /	CUPBOARD W/ DOORS: FULL HEIGHT
J.FS /	FURNITURE: SEATING
J.PG /	PANEL: GABLE
JB.01 /	
JT.01	CLASSROOM DESK (CD)
K.F.D	FURNITURE: DINING
K.WS	WASHROOM: SHOWER
ŁV	SCREENS & SHADING: HORIZONTAL
LV-01	
	LOUVRE
OL1	ROUND LIGHT: CEILING MOUNTED INTERNAL
W-##	WALL - TYPE ##

		Current
No.	Name	Revision
0000	COVER SHEET	J
0001	LEGENDS / NOTES	I
0003	SITE ANALYSIS PLAN	I
0004	BLOCK ANALYSIS PLAN	I
0005	SITE PLAN	I
0006	DEMOLITION PLAN	I
0007	CONCEPT VIEW 01- EAST	I
8000	CONCEPT VIEW 02 - WEST	I
1000	GA PLAN - GROUND LEVEL	L
1001	GA - ROOF PLAN	J
1002	GROUND LEVEL CALLOUT	J
1003	MECHANICAL LAYOUT - GROUND LEVEL	J
1004	MECHANICAL LAYOUT - ROOF LEVEL	J
1005	GA PLAN - WALL CLASSIFICATION AND ACOUSTIC GRADINGS	G
2000	ELEVATIONS NORTH & SOUTH	J
2001	ELEVATIONS EAST & WEST	J
2100	SECTIONS AA & BB	Н
2101	SECTIONS CC & DD	Н
3000	MATERIALS AND FINISHES	I
4000	SHADOW DIAGRAMS - PLAN	G
4001	SHADOW DIAGRAMS - ELEVATION EAST	G
4002	SHADOW DIAGRAMS - ELEVATION NORTH	F
N01	NOTIFICATION - ELEVATIONS & SITE PLANS	F
N02	NOTIFICATION - SHADOW DIAGRAMS	F

GENERAL NOTES

- ARCHITECTURAL DRAWINGS TO BE READ IN CONJUNCTION WITH DESIGN DOCUMENTATION FROM ALL OTHER SERVICES AND DESIGN CONSULTANTS INCLUDING BUT NOT LIMITED TO SCHEDULES, SPECIFICATIONS AND REPORTS.
- ALL NEW BUILDING WORKS TO BE IN COMPLIANCE WITH MANDATORY DESIGN REQUIREMENTS: LEGISLATION, REGULATIONS, THE NATIONAL CONSTRUCTION CODE,
- THE BUILDING ACT, LOCAL AUTHORITY BY-LAWS & RELEVANT AUSTRALIAN STANDARD. NEW FINISHES AND MATERIALS TO COMPLY WITH NCC FIRE HAZARD INDICES SPECIFICATION C 1.10.
- ANY SUBSTITUTION OF MATERIAL OR PRODUCT TO BE APPROVED BY ARCHITECT IN WRITING. CONTRACTOR TO PROVIDE ALL RELEVANT INFORMATION / DATA REQUIRED FOR ALTERNATIVE TO BE CONSIDERED.
- CONTRACTORS ARE RESPONSIBLE FOR CONDUCTING A SITE VISIT PRIOR TO TENDERING - AND REPORT ANY DISCREPANCIES ONSITE (OR IN DOCUMENTATION) TO ARCHITECT FOR CLARIFICATION.
- THE MANUFACTURERS RECOMMENDATIONS SUPPLY EXTRA PRODUCT/ACCESSORIES AND MATERIAL WHERE SPECIFIED FOR FUTURE REPLACEMENT. BUILDER TO ENSURE THAT ALL NON-STRUCTURAL ELEMENTS LISTED IN AS1170.4

ALL APPLIANCES AND SPECIFIC ITEMS ARE TO BE INSTALLED IN FULL COMPLIANCE OF

- CLAUSE 8.1.4 HAVE BEEN DESIGNED AND CERTIFIED FOR SEISMIC LOADS IN THEIR DESIGN AND INSTALLATION TO COMPLY WITH NCC REQUIREMENTS.
- MECHANIC, HYDRAULIC AND ELECTRICAL (SUB-CONTRACTORS) TO READ DRAWINGS IN CONJUNCTION WITH ARCHITECTURAL DRAWINGS DETAILS FOR ALL SERVICES SETOUT. WATERPROOFING AND TERMITE PROTECTION TO BE PROVIDED TO ALL NEW
- INTERNAL/EXTERNAL WORKS INCLUDING RETAINING WALLS, STEP DOWN AND THE LIKE. PROVIDE PHYSICAL TERMITE BARRIER TO ALL NEW BUILDINGS. INSTALLED AS PER MANUFACTURERS RECOMMENDATIONS IN COMPLIANCE WITH CODE AND AUSTRALIAN
- STANDARDS. CERTIFICATION (INCLUDING SUPPORTING DOCUMENTATION) TO BE SUBMITTED TO SUPERINTENDENT ON COMPLETION OF INSTALLATION BUILDER SHALL BE RESPONSIBLE FOR THE WATER TIGHTNESS OF ALL WORKS, AND SHALL INCLUDE FLASHING, MEMBRANES AND DAMP PROOF COURSES NECESSARY TO PREVENT ENTRY OF MOISTURE AND DAMPNESS. FALLS IN SLAB TO COMPLY WITH AUSTRALIAN STANDARDS AND FALL AWAY FROM BUILDING NOT TO ALLOW ANY PONDING. PROVIDE FLOOR WASTES AND FALLS IN WET AREAS TO PREVENT PONDING
- IN INTERNAL SPACES. • ALL EXTERNAL FURNITURE, FIXTURES AND FITTINGS TO BE A HIGH DURABILITY AND BE VANDAL RESISTANT. EXPOSED EDGES (WALLS, SEATS ETC) TO BE INSTALLED WITH SKATEBOARD DETERGENTS.
- ALL MATERIALS, WORKMANSHIP, TESTING AND COMMISSIONING OF SITE SERVICES SHALL COMPLY WITH CURRENT AND RELEVANT AUSTRALIAN STANDARDS AND STATUTORY REQUIREMENTS.
- AT PRACTICAL COMPLETION PROVIDE ALL TECHNICAL INFORMATION/ MAINTENANCE MANUALS, WARRANTIES AND CERTIFICATES AS PART OF OPERATIONS AND MAINTENANCE MANUAL.
- COMPLY WITH SECTION J REPORT REQUIREMENTS.
- J4 BUILDING FABRIC ,J4D4ROOF & CEILING AND J4D6WALLS & GLAZING IN CONSTRUCTION DETAILING AND EXECUTION OF THE WORK.
- BUILDING ENVELOPE THERMAL REQUIREMENTS TO BE IN ACCORDANCE WITH THE SECTION J REPORT

ROOF PLAN NOTES

THE USE OF ANGLE GRINDERS ON THE ROOF SYSTEM IS PROHIBITED.

- NEATLY SCRIBE FLASHING TO SUIT ROOF PROFILES.
- COVER FLASHING TO ROOF PENETRATIONS TO EXTEND FROM RIDGE, NO DECKTITE FLASHINGS.
- TURN UP VALLEYS AT RIDGE & INSTALL PROFILED BITUMEN IMPREGNATED FOAM SEALING STRIP UNDER FLASHING.
- EAVES GUTTER 0.6mm COLORBOND WITH GALVANISED STEEL BRACKET SUPPORTS AS DETAILED.
- EAVES GUTTERS TO ALL ROOFS WITH OVERFLOW RELIEF AT THE FRONT OF GUTTERS GUTTERS TO HAVE A FALL TOWARDS OUTLET OF 1:500 MIN. AND BE INSTALLED WITH REMOVABLE LEAF GUARDS WHERE REQUIRED
- EAVES GUTTERS AND VALLEYS TO BE FABRICATED TO ENSURE JOINTS ARE NOW? SUBJECT TO CREVICE CORROSION. CONTINUOUS LENGTHS OF GUTTERING TOTAL EXPANSION JOINTS WITH STOP ENDS WITH A SADDLE OVER FLASHING.
- ALL ROOF FASTENERS TO BE CLASS 4 FINISH.
- REFER FINISHES SCHEDULE FOR ROOF INSULATION.
- ALL SUSCEPTIBLE OPENINGS INTO ROOF AREA SHALL BE PROVIDED WITH BIRD AND VERMIN PROOFING. FRAMING UNDER ROOFED AREAS TO BE ENCLOSED TO PREVENT NESTING AND ROOSTING BIRDS.
- BASE OF DOWNPIPE SHALL BE SEPARATED BY A MIN 25mm GAP BE, WEEN PIPE END AND GRATED INLET TO PREVENT BACK UP + PROVIDE ACCESS OR NING FOR MAINTENANCE.

SAFE ROOF ACCESS NOTES

- INSTALL A COMPLETE SAFE ROOF ACCESS AND SAFETY HARNESS SYSTEM TO ASSIST IN THE SAFE ACCESS AND MAINTENANCE OF THE WHOLE OF THE ROOF AREAS OF THE BUILDING AT THE ROOF LEVEL INCLUDING ALL BOX AND EAVES GUTTERS. THE SYSTEM IS TO COMPLY TO AS/NZS 1891.1 AND 2.
- ALL PRODUCTS PROPOSED WILL BE PROPRIETARY ITEMS MANUFACTURED AND SUPPLIED BY A SPECIALIST MANUFACTURER AND INSTALLED BY CERTIFIED CONTRACTORS.
- PROVIDE CERTIFICATES BY RELEVANT AUTHORITIES STATING COMPLIANCE WITH ALL OCCUPATIONAL HEALTH AND SAFETY REQUIREMENTS CLAIMED BY THE
- MANUFACTURER PROVIDE WRITTEN PROPOSAL COMPLETE WITH ALL REQUIRED SHOP DETAILING, PERFORMANCE CHARACTERISTICS AND WORK HEALTH AUTHORITY CONCURRENCE FOR USE ON THIS BUILDING INCLUDING TRAINING PROGRAM AND ACCREDITATION PROCESS (WHERE REQUIRED).
- LIAISE WITH THE BUILDING STRUCTURAL ENGINEER INCORPORATION OF ALL BUILDING STRUCTURAL COMPONENTS AS SUBSTRATES FOR THE CONNECTION OF ANY FALL ARREST AND TRAVEL RESTRAINTS SYSTEMS. CERTIFICATION OF THE APPROVED SYSTEM IS TO ENCOMPASS THE ADEQUACY OF THE SUBSTRATE TO WHICH THE SYSTEM IS ATTACHED. PROVIDE COMPLIANCE CERTIFICATION OF THE INSTALLED SYSTEM UPON COMPLETION OF THE WORKS, CERTIFICATION IS TO INCLUDE CONFIRMATION THAT THE APPROPRIATE TRAINING PROGRAM HAS BEEN PROVIDED TO THE NOMINATED PERSONS AND COMPLETED AND ACCREDITATION VALIDATED.

FLASHING NOTES

- FLASHINGS INDICATE ARCHITECTURAL INTENT ONLY. SITE CHECK DIMENSIONS OF ALL FLASHINGS PRIOR TO MANUFACTURE. OBTAIN APPROVAL FOR ANY VARIATIONS PRIOR TO PROCEEDING.
- FLASIHINGS AND CAPPINGS SHALL BE RATIONALISED WHERE PRACTICAL. ROOF AND WALL FLASHINGS GENERALLY TO BE 0.6mm COLORBOND.
- CHECK ON SITE PROFILES AND DIMENSIONS OF CAPPING AND FLASHINGS PRIOR TO
- MANUFACTURE. / ENSURE ALL FLASHINGS AND CAPPINGS OVERLAP DECK BY MIN. 200mm WHERE
- PROVIDE ADDITIONAL FLASHINGS AS REQUIRED TO ACHIEVE A WATERPROOF ROOF
- MINIMUM COVER: RIDGE CAPPING 250mm, BARGE CAPPING 200mm

VAPOUR BARRIER AND INSULATION NOTES

MATERIALS AND INSTALLATION

- SAFETY MESH: AS PER SAFEBRIDGE INSULATION SYSTEM REQUIREMENTS. GLASSWOOL ROOF INSULATION: BRADFORD ANTICON 130 R3.0 BLANKET WITH REFLECTIVE
- FOIL ON SAFEBRIDGE INSULATION SYSTEM. VAPOUR PERMIABLE MEMBRANE: ENVIROSEAL PROCTORWRAP HTR MEMBRANE TO ROOF
- WALL AIR BARRIER: BRADFORD ENVIROSEAL PROCTORWRAP CW. INSTALL AS PER MANUFACTURERS RECOMMENDATION FOR CLIMATIC ZONE UNDER MATIONAL CONSTRUCTION CODE (NCC).

GENERAL NOTES FOR ACCESSIBLE FACILITIES

- ACCESSIBLE CUBICLE AND AMBULANT CUBICLE TO COMPLY WITH AS 1428 REQUIREMENTS. ALL DIMENSIONS SHOWN ARE CLEAR INTERNAL, BUILDER TO ENSURE ALLOWANCES FOR ALL LININGS & FINISHES.
- ALL AMBULANT ACCESSIBLE CUBICLES TO BE 900-920mm WIDE CLEAR AND 900mm MIN. CLEAR
- FROM FRONT FACE OF TOILET PAN. FLOOR GRADIENTS IN ACCESSIBLE PERSONS TOILET TO BE BETWEEN 1 in 60 AND 1 in 80 FOR
- SHOWERS, AND BETWEEN 1 in 80 AND 1 in 100 FOR GENERAL AREAS. SET-OUT DIMENSIONS OF ALL FIXTURES & FITTINGS TO BE FROM FINISHED FLOOR AND WALL SURFACES AND MUST COMPLY WITH AS 1428 ALLOW FOR THESE FINISHES WHEN SETTING
- OUT FROM BASE (UNFINISHED) WALLS AND FLOORS. ACCESSIBLE TOILETS SHALL BE IDENTIFIED WITH BRAILLE AND TACTILE SIGNAGE COMPLYING WITH NCC D3.6. ENSURE INTERNATIONAL SYMBOLS FOR ACCESS COMPLYING WITH AS/NZS
- 1428.1 ARE PROVIDED ON THE LATCH SIDE OF DOORS AND MOUNTED 1250-1350mm AFL. SWITCH AND POWER POINTS IN ACCESSIBLE TOILETS TO BE MOUNTED 1000 AFL AND NOT
- LESS THAN 500 FROM INTERNAL CORNERS.
- DOOR TO ACCESSIBLE FACILITIES/TO HAVE AN IN USE INDICATOR
- DOOR TO ACCESSIBLE FACILITIES TO BE REMOVABLE FROM OUTSIDE.
- PROVIDE AT LEAST 30% MIN. LUMINANCE CONTRAST (BETWEEN DOOR LEAF v. DOOR FRAME OR DOOR LEAF v. ADJACENT WALL) AT ALL DOORWAYS WHERE DISABLED ACCESSIBILITY IS REQUIRED IN ACCORDANCE WITH AS 1428.1.

EXISTING TREES PROTECTION NOTES

CONTRACTOR IS RESPONSIBLE TO MAINTAIN AND PROVIDE TEMPORARY FENCING AROUND EXISTING TREES TO BE RETAINED DURING THE COURSE OF CONSTRUCTION. ANY EXISTING TREES AND VEGETATION AFFECTED BY THE CONSTRUCTION WORKS ARE TO BE REINSTATED AT THE COMPLETION OF WORKS.

PARTITION PLAN NOTES:

- ALL PARTITION FRAMING SIZES ARE NOMINAL AND ARE TO BE CONFIRMED BY SUB-
- CONTRACTOR. NOTIFY SUPERINTENDENT OF CHANGES PRIOR TO MANUFACTURE. PROVIDE ALL NECESSARY ACCESSORIES IN ACCORDANCE WITH MANUFACTURERS
- RECOMMENDATIONS AND FIXING DETAILS FOR ALL PARTITION WALLS.
- ALL PARTITION WALLS TO EXTEND TO UNDERSIDE OF STRUCTURAL SLAB OR ROOF FRAMING UNLESS NOTED OTHERWISE
- OF CIRCULATION, ACCESS, PARTITION SETOUT AND OPENINGS TO BE IN
- ACCORDANCE WITH AS.1428.1-2009 SENERAL LAYOUT AND WALL SETOUT PLANS TO BE READ IN CONJUNCTION WITH WALL
- TYPE SCHEDULE AND BE COORDINATED WITH SERVICES ENGINEERING DOCUMENTATION.
- BUILDER IS RESPONSIBLE FOR COORDINATING AND ALLOWING FOR NOGGINS AND
- EXTRA STRUCTURAL SUPPORT REQUIRED FOR FIXTURES AND FITTING INCLUDING BUT NOT LIMITED TO JOINERY, MECHANICAL AND ELECTRICAL EQUIPMENT.
- DOOR AND WINDOW NUMBERS TO BE READ IN CONJUNCTION WITH DOOR AND WINDOW SCHEDULE AND DOOR HARDWARE SCHEDULE
- BUILDER TO ENSURE THAT ALL NON-STRUCTURAL ELEMENTS LISTED IN AS1170.4 CLAUSE 8.1.4 HAVE BEEN DESIGNED AND CERTIFIED FOR SEISMIC LOADS IN THEIR
- DESIGN AND INSTALLATION TO COMPLY WITH NCC REQUIREMENTS. REFER FINISHES SCHEDULE DETAIL DRAWINGS FOR FURTHER INFORMATION ON
- SKIRTING TYPE, MATERIAL, COLOUR ETC. PROVIDE FLUSH SET FIBRE CEMENT SHEETING OR MOISTURE RESISTANT
- PLASTERBOARD TO ALL PARTITIONS.
- ENSURE ACOUSTIC INTEGRITY BY PROVIDING SUITABLE SEALING SOLUTION TO ALL PARTITIONS.
- TYPICAL ELEVATIONS/DETAILS TO BE READ IN CONJUNCTION WITH THE FLOOR PLANS. LOCATION OF FITTINGS AND FIXTURES ON PLAN TO TAKE PRECEDENCE OVER TYPICAL ELEVATIONS. CLARIFY WITH ARCHITECT IF IN DOUBT.

REFLECTED CEILING PLAN NOTES

- DO NOT SCALE OFF THE DRAWINGS.
- THE CONTRACTOR SHALL CARRY OUT A TRIAL SET-OUT OF ALL CEILING GRIDS. GENERALLY SET-OUT ROOMS AS INDICATED ON DRAWINGS. WHERE NO SETOUT
- SHOWN ASSUME CENTRAL SET-OUT.
- "EQ" RELATES ONLY TO OPPOSING DIMENSION IN THAT DIMENSION LINE. CHECK ALL DIMENSIONS ON SITE WITHIN ROOMS PRIOR TO INSTALLATION OF FITTINGS.
- NOTIFY SUPERINTENDENT OF ANY DISCREPANCIES PRIOR TO PROCEEDING. RCP TO BE READ IN CONJUNCTION WITH ALL MECHANICAL AND ELECTRICAL SERVICES
- DRAWINGS AND SPECIFICATIONS. USE ARCHITECTURAL RCP FOR GRID CEILING SET-OUT OF ALL ELECTRICAL AND MECHANICAL FIXTURES AND FITTINGS TO BE
- CONFIRMED ON SITE WITH THE SUPERINTENDENT PRIOR TO FRAMING, CUTTING ETC.
- CEILING GRIDS SHALL BE 2 DIRECTIONAL, WHITE POWDERCOATED FINISH.
- PROVIDE EXPANSION JOINTS TO ALL NEW FLUSHSET PLASTERBOARD/ FIBRE CEMENT CONTRACTOR TO COORDINATE THE SERVICES AND LOCATION OF ACCESS PANELS TO
- PLASTERBOARD CEILING WITH REFERENCE SERVICES DOCUMENTATION AND SPECIFICATIONS. SETOUT FOR ACCESSPANEL TO BE CONFIRMED WITH SUPERINTENDENT PRIOR TO INSTALLATION.
- ALL CEILINGS TO BE DESIGNED AND CONSTRUCTED TO COMPLY WITH SEISMIC DESIGN **REQUIREMENTS AS PER AS1170.4**

WET AREA MEMBRANE NOTES

- WET AREA MEMBRANE TO AS 3140 2010.
- PROVIDE WET AREA MEMBRANE TO FLOORS AND 200mm HIGH TO WALLS

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DO NOT scale off these drawings.

DEVELOPMENT **APPLICATION** 0m 1 2 3 4 5

STATUS

CUMBERLAND CITY COUNCIL






Gadigal Country Level 5, 111-117 Devonshire Street Surry Hills, NSW 2010 T +61 2 8396 9500 syd@modedesign.com.au ABN: 65 112 807 931


PROJECT **GUILDFORD POOL** MODERNISATION PROJECT LOT 21, DP 1018330, 1 TAMPLIN ROAD, GUILDFORD

DRAWING TITLE LEGENDS / NOTES

CHECKED SCALE @ A1 SCALE @ A3 03/07/2024 10:52:12 AM PROJECT No STAGE DRAWING No REVISION MMX-AR-000'

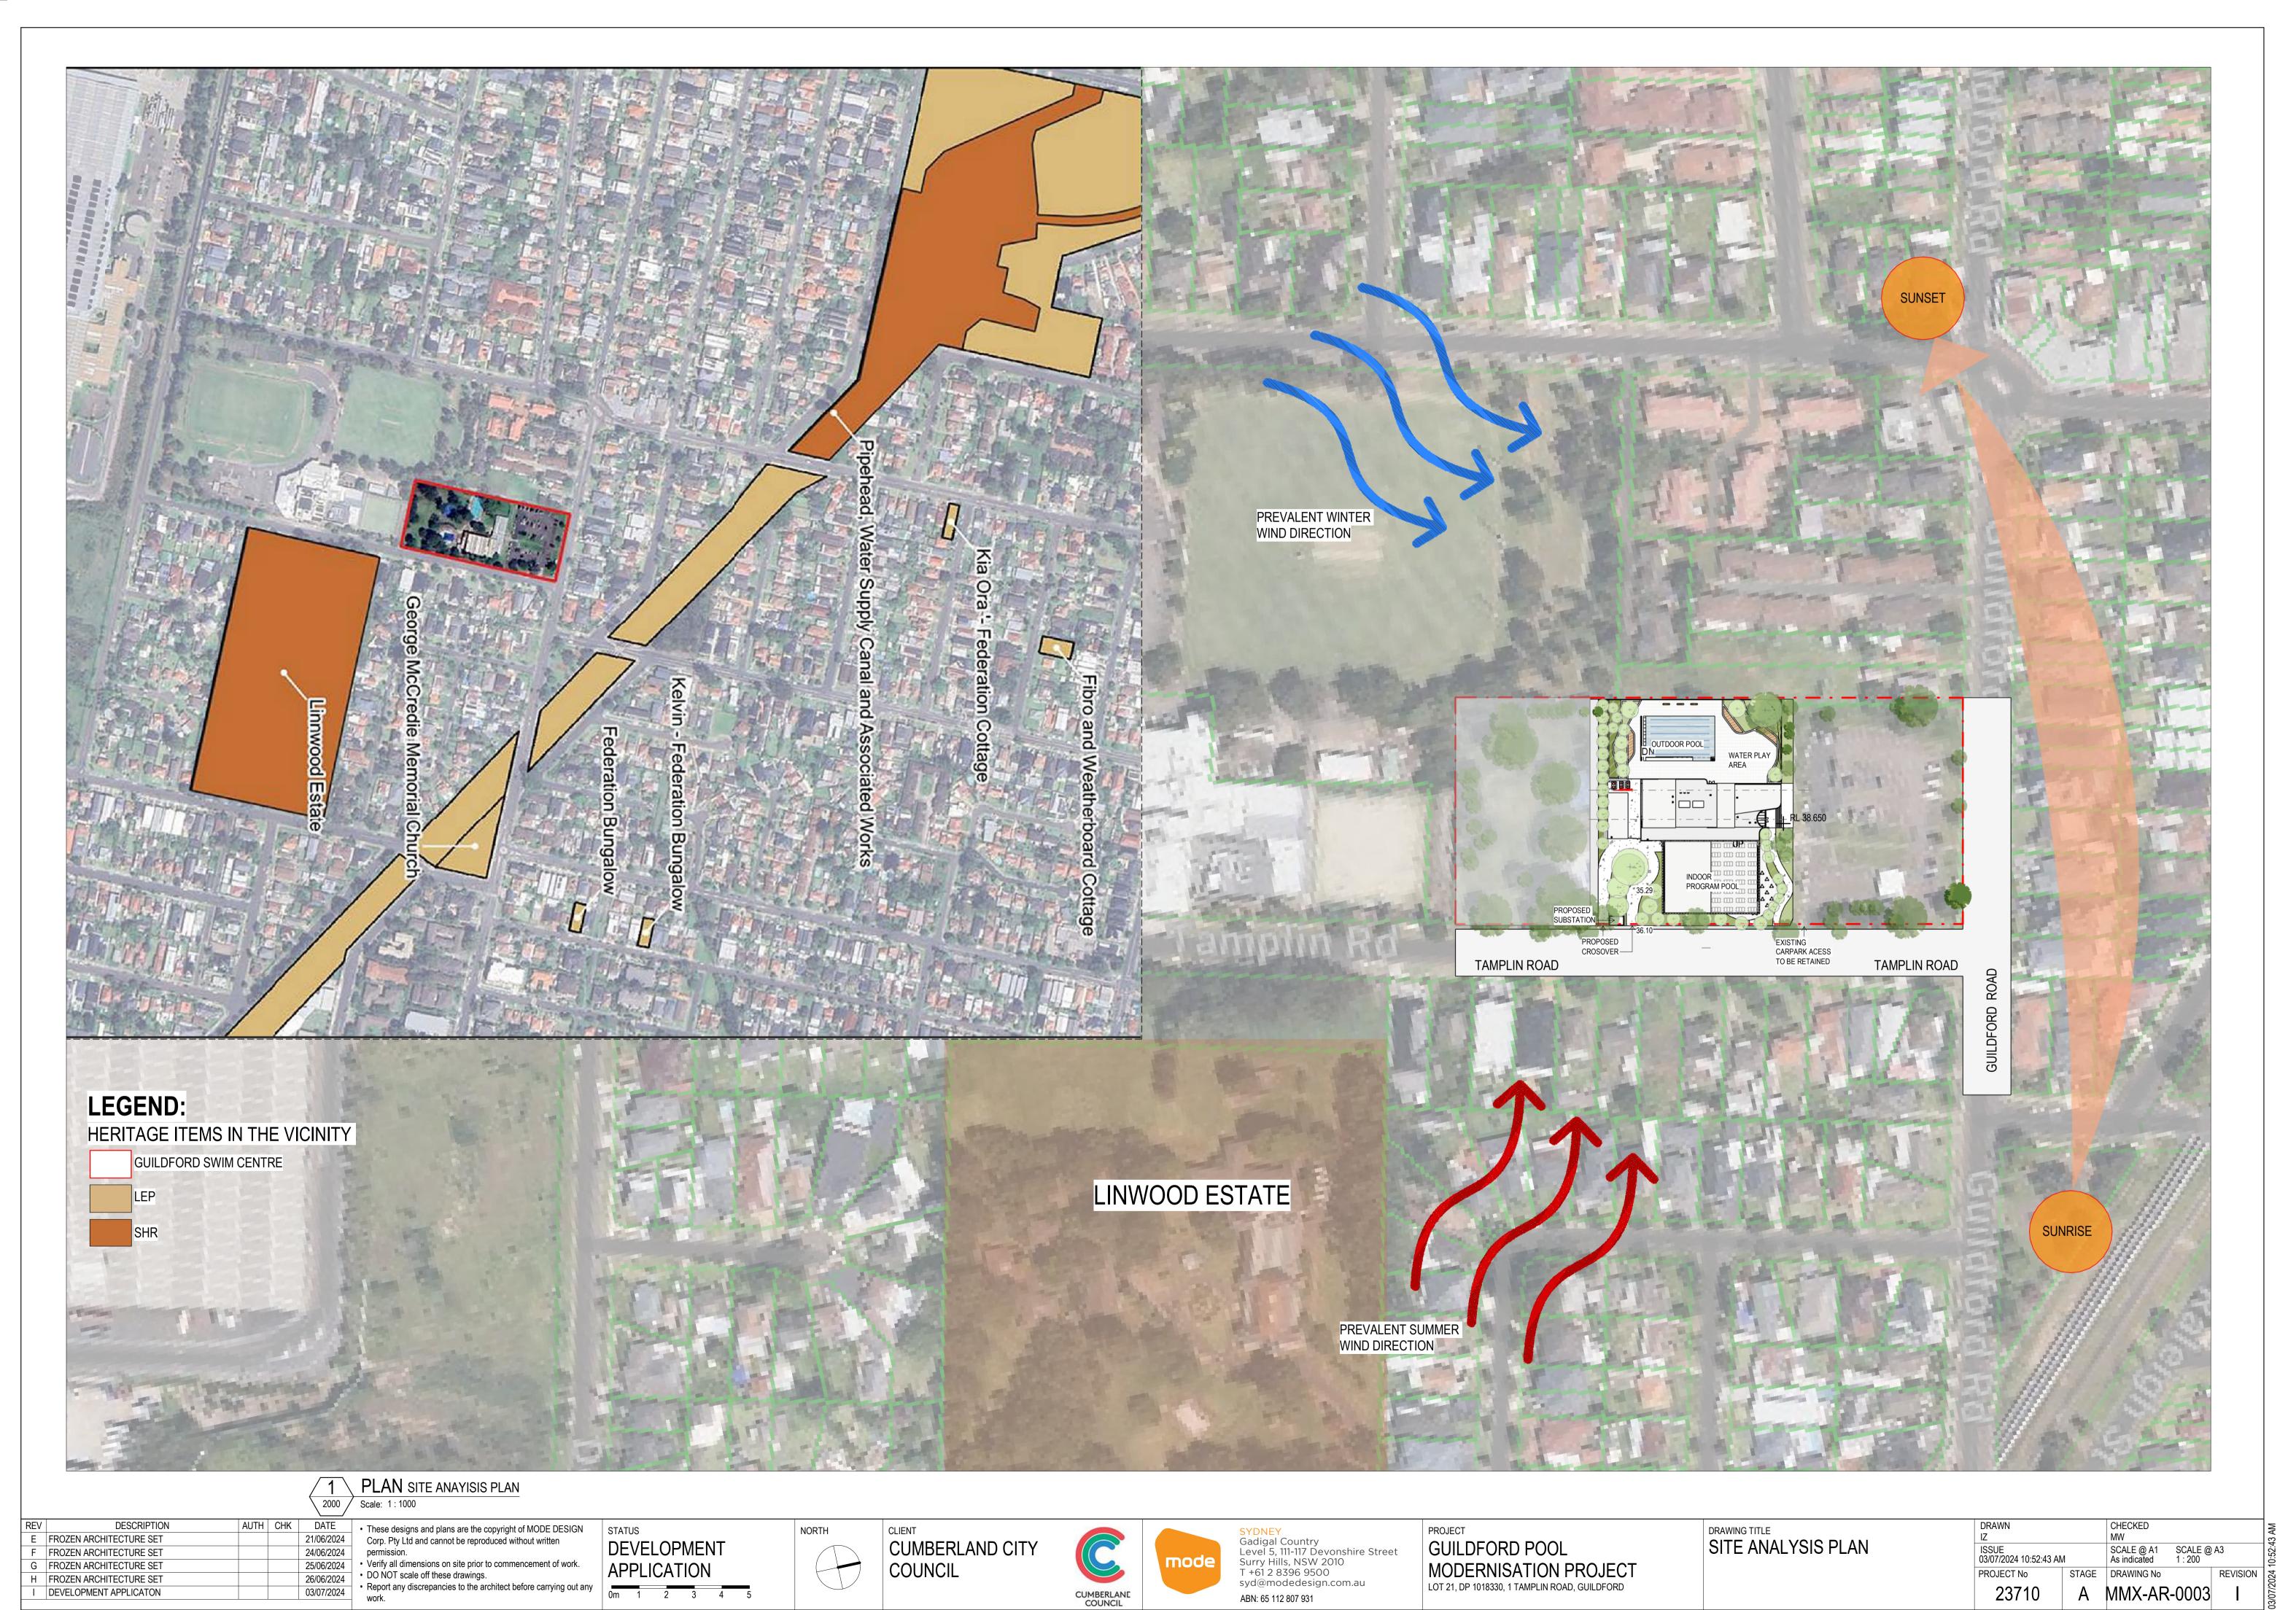

Document Set ID: 11236292 Version: 1, Version Date: 14/11/2024

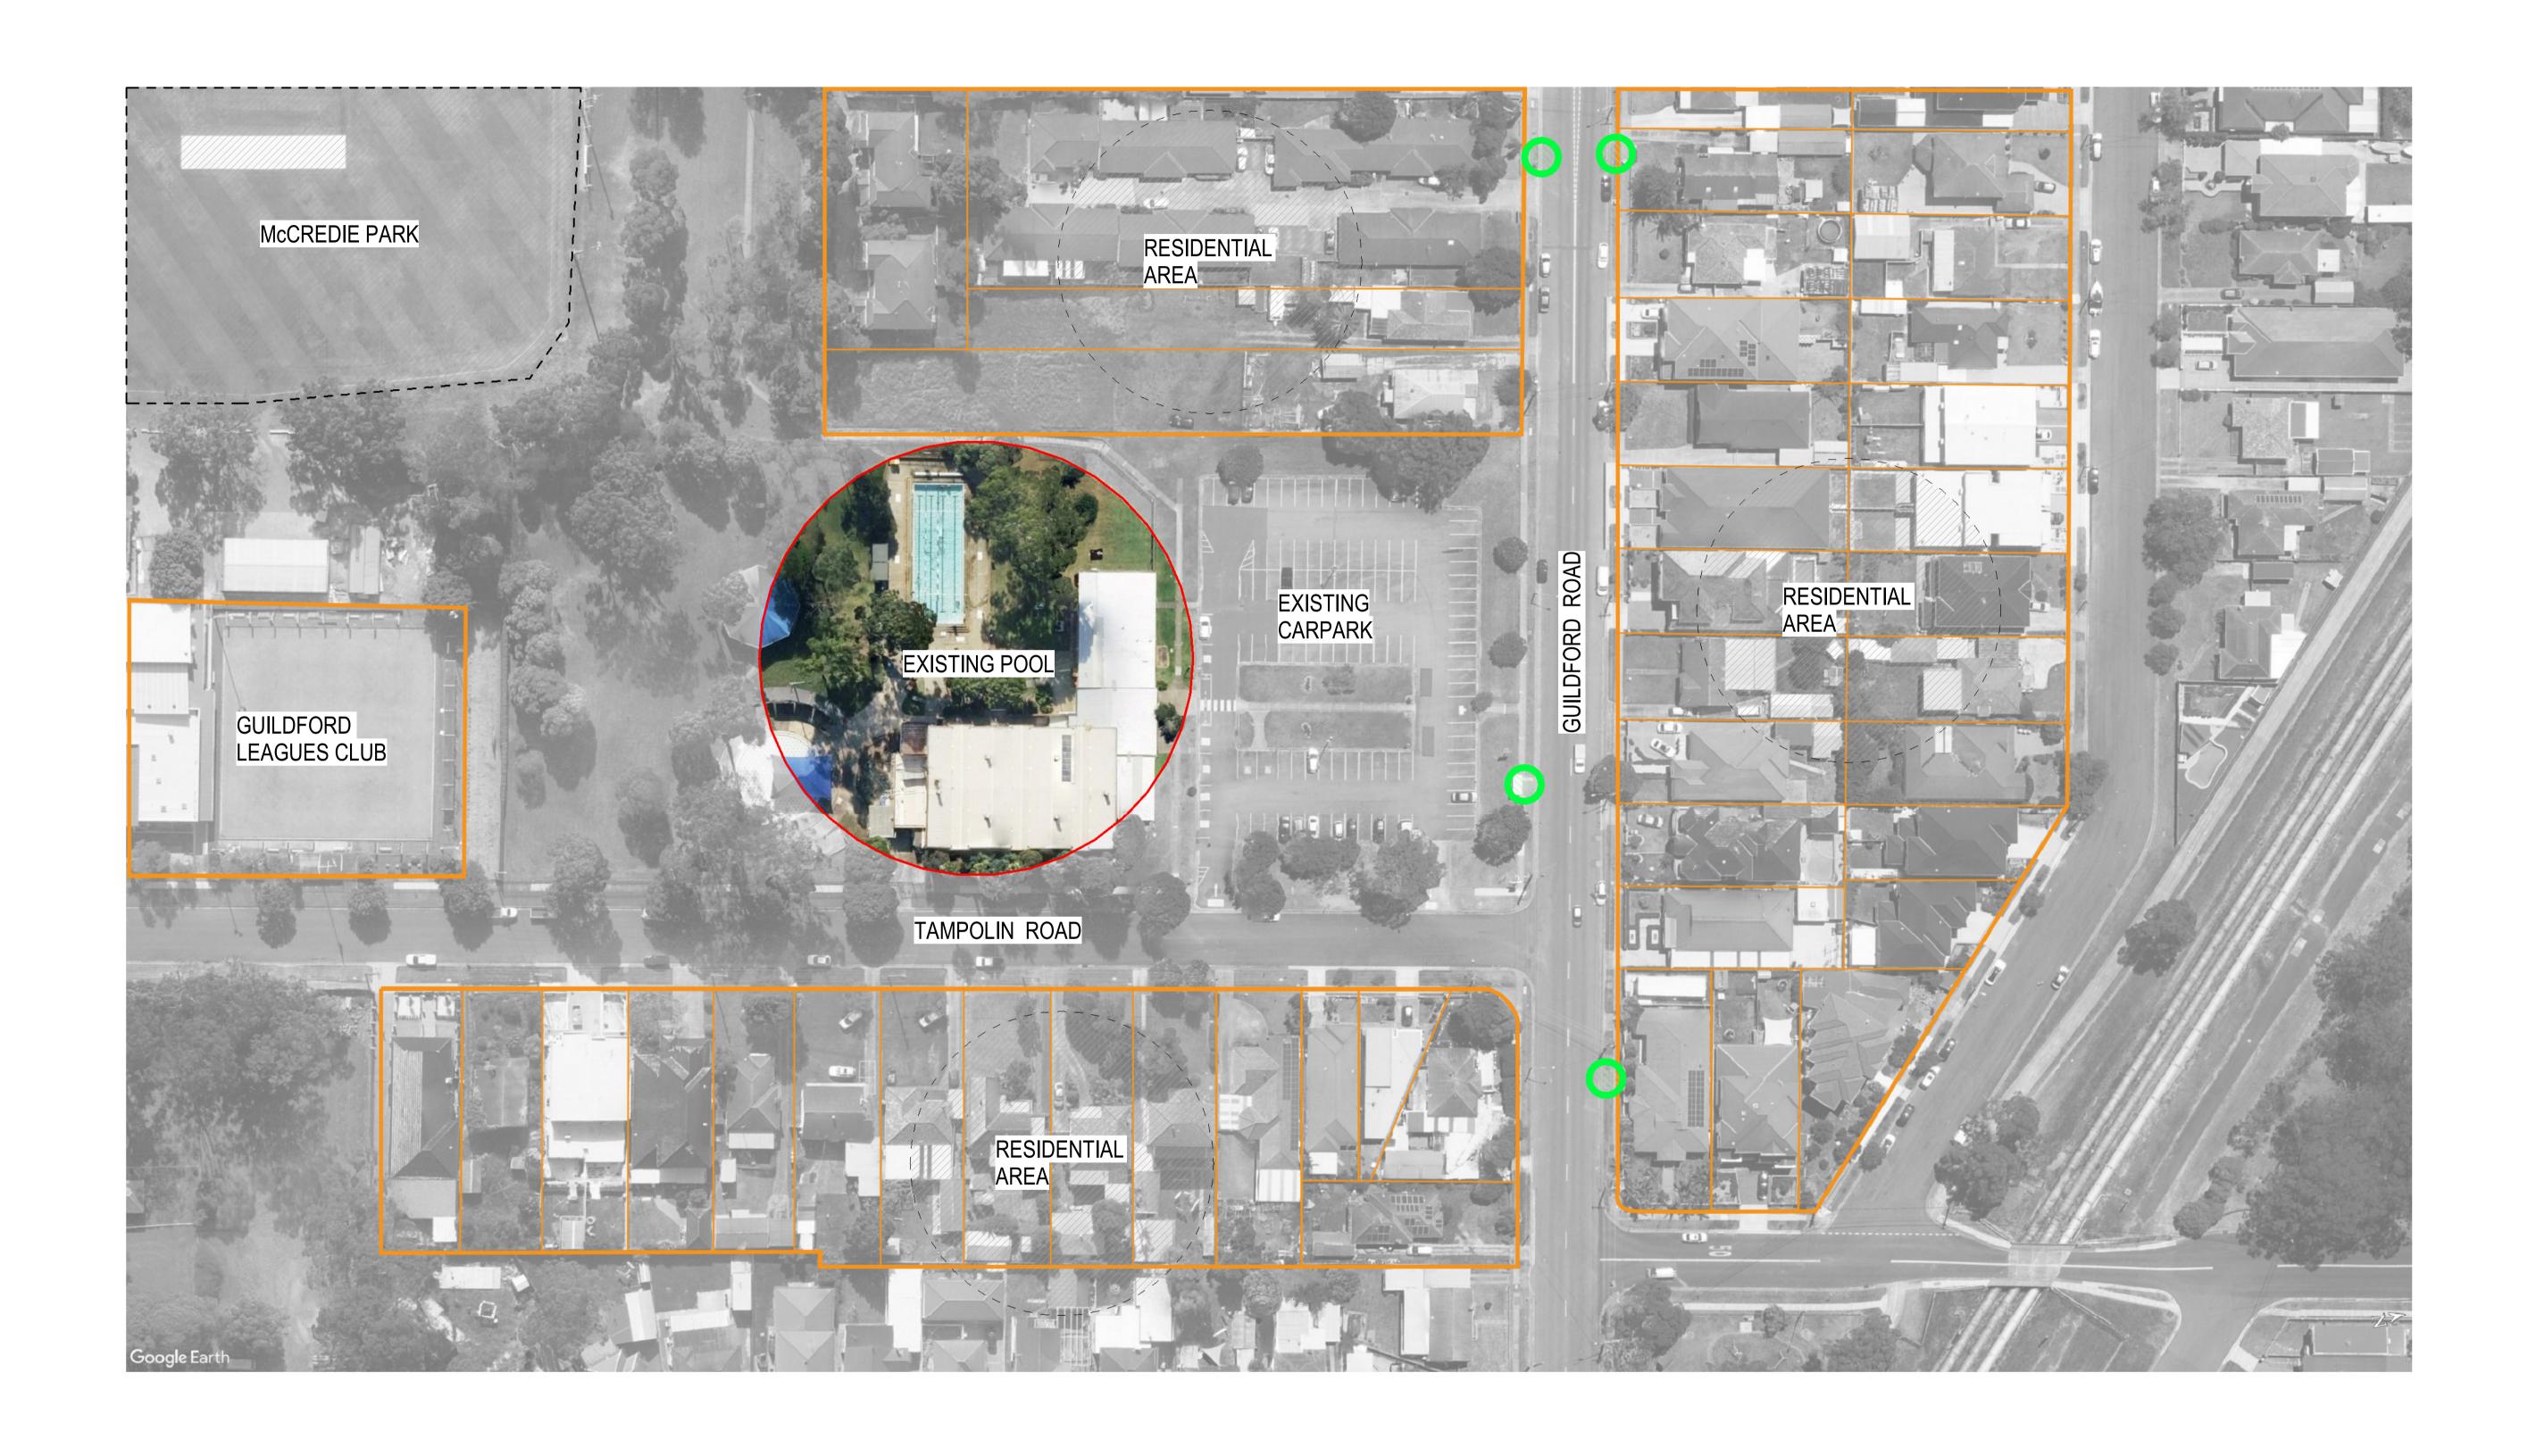

PLAN BLOCK ANALYSIS PLAN
Scale: 1:1

03/07/2024

LEGEND



BUS STOPS

 REV
 DESCRIPTION
 AUTH
 CHK
 DATE

 E
 FROZEN ARCHITECTURE SET
 21/06/2024

 F
 FROZEN ARCHITECTURE SET
 24/06/2024

 G
 FROZEN ARCHITECTURE SET
 25/06/2024

 H
 FROZEN ARCHITECTURE SET
 26/06/2024

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DEVELOPMENT
APPLICATION

Om 1 2 3 4 5

NORTH

CUMBERLAND CITY
COUNCIL






PROJECT
GUILDFORD POOL
MODERNISATION PROJECT
LOT 21, DP 1018330, 1 TAMPLIN ROAD, GUILDFORD

BLOCK ANALYSIS PLAN

| DRAWN | IZ | MW | SCALE @ A1 | SCALE @ A3 | 1:1 | 1:200 | STAGE | DRAWING No | REVISION | A | MMX-AR-0004 | I | MMX-AR-0004 | MMX-AR-0004 | I | MMX-AR-0004 | MMX-AR-0004 | I | MMX-AR-0004 | I | MMX-AR-0004 | I | MMX-AR-0004 | MMX-AR-0004 | I | MMX-AR-0004 | MMX-0004 | MMX-0004 | MMX-0004 | MMX-0

I DEVELOPMENT APPLICATION

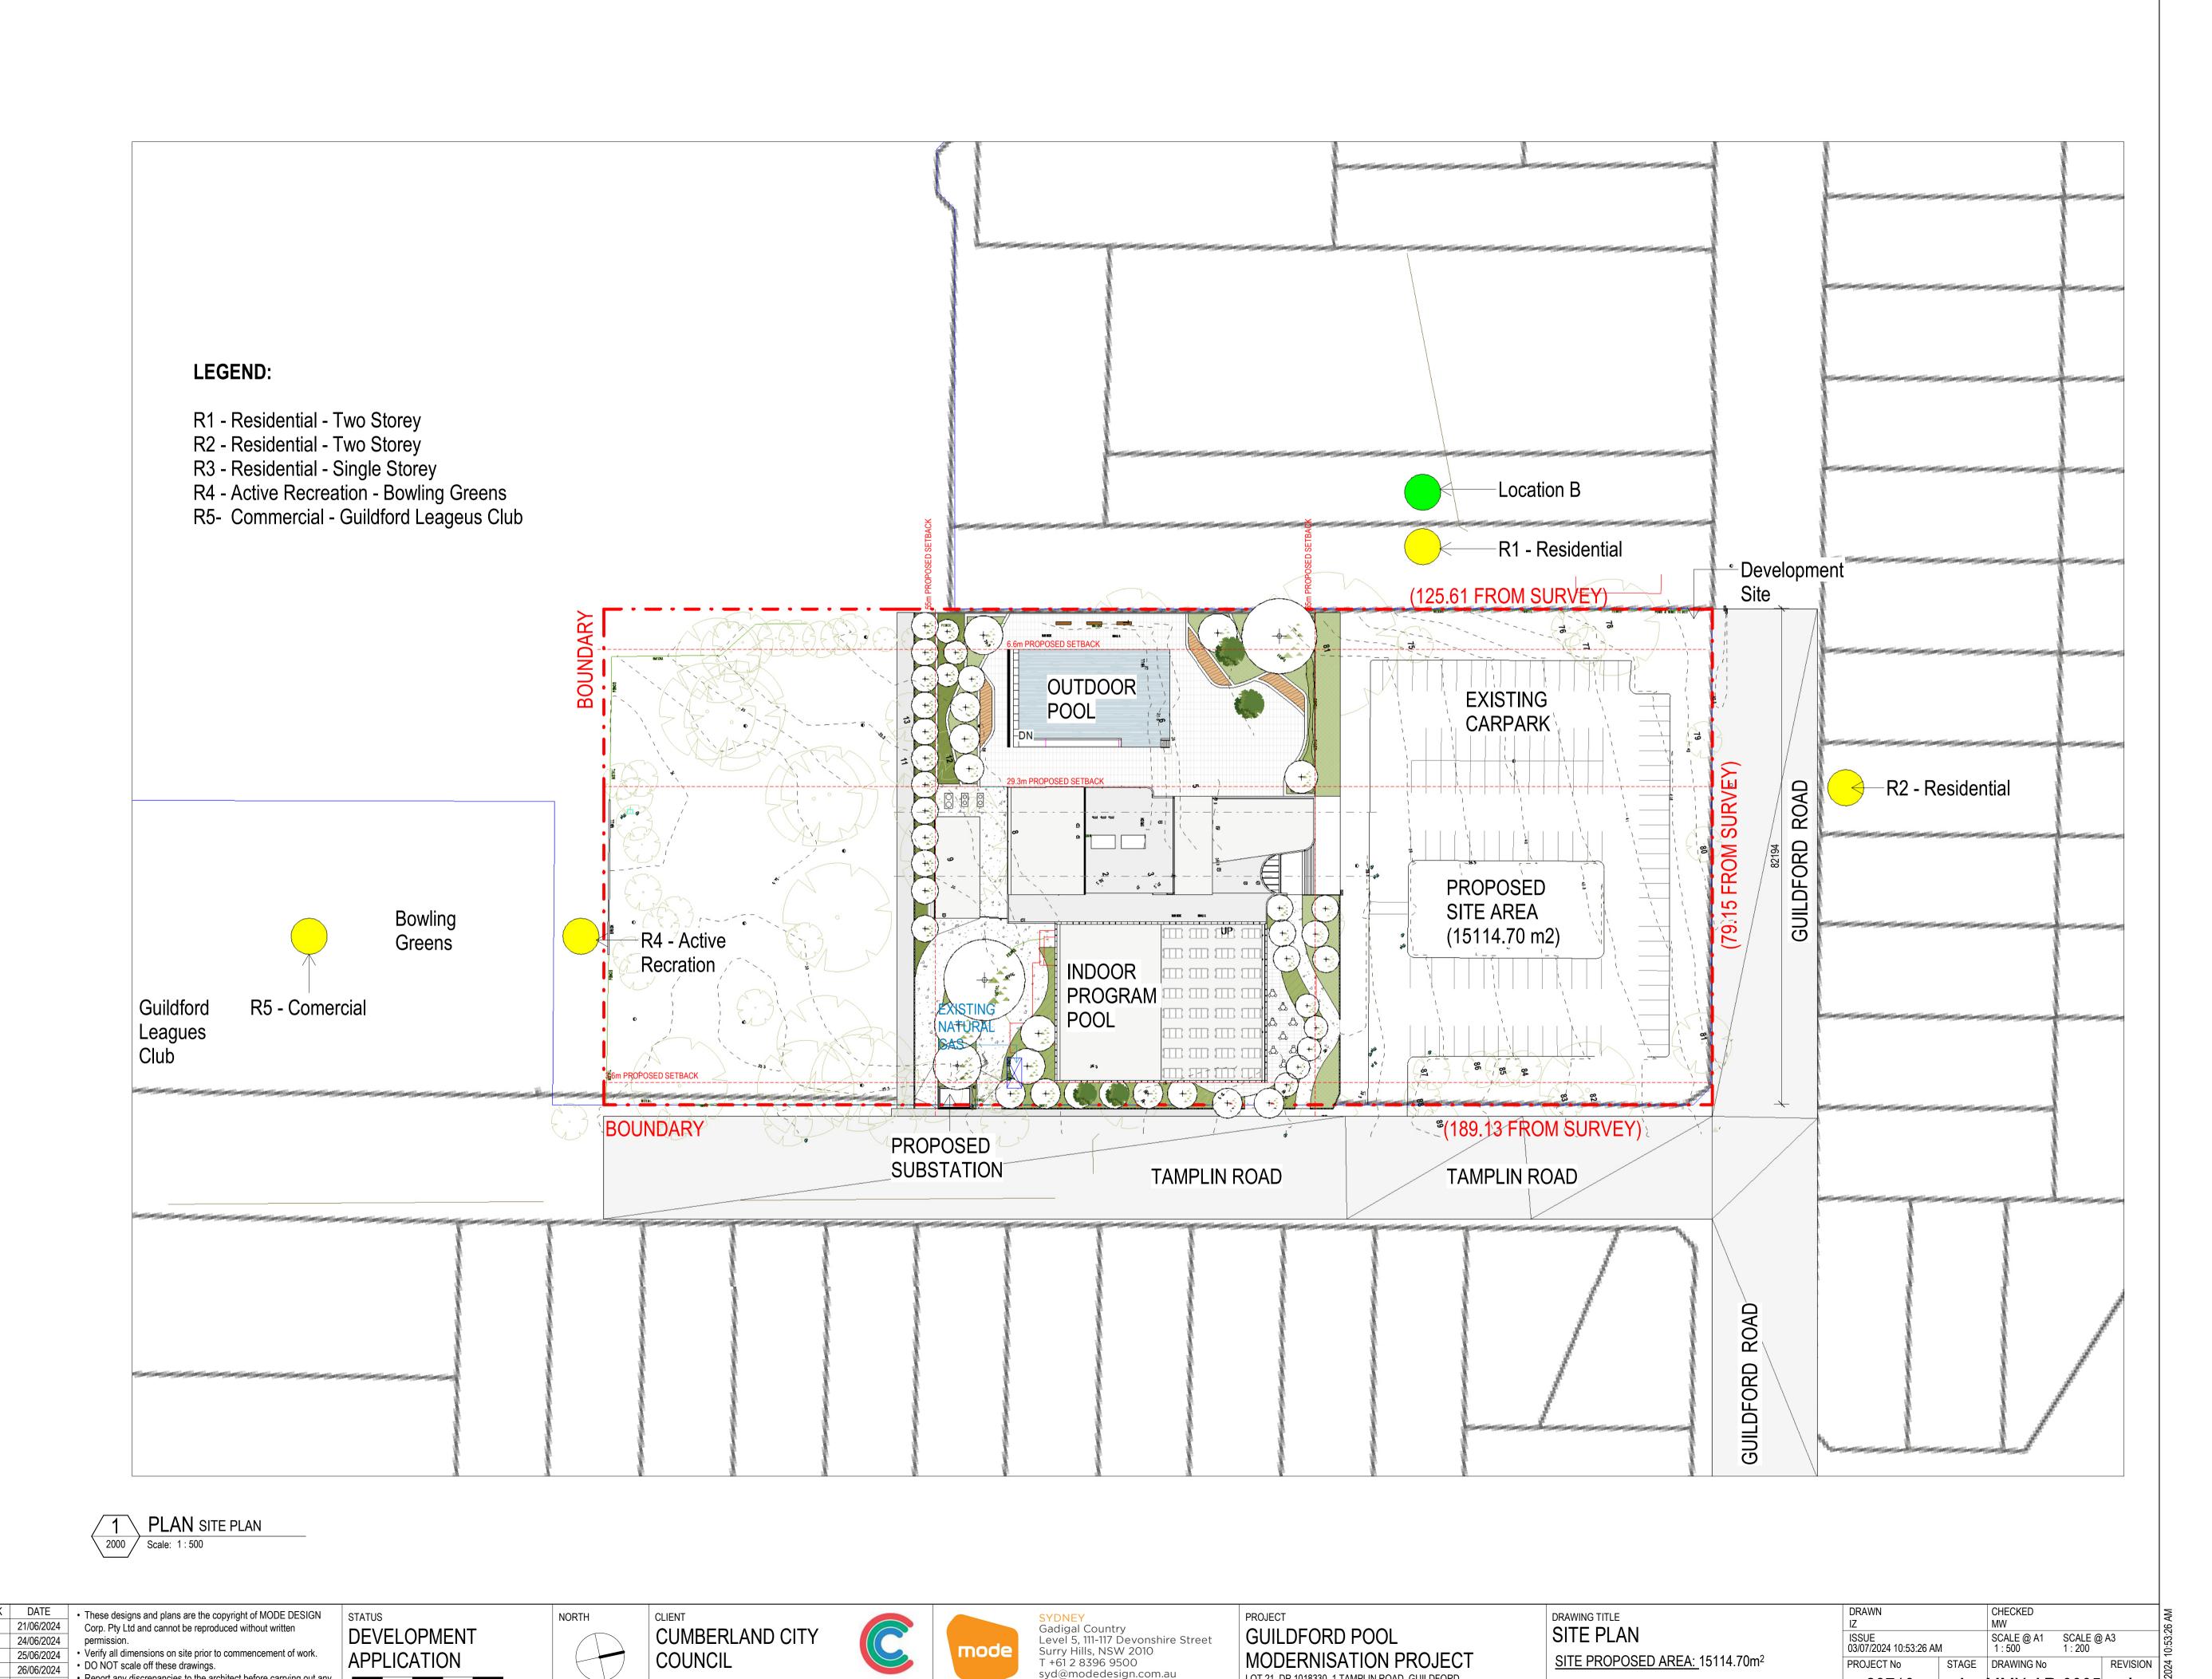

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ABN: 65 112 807 931

LOT 21, DP 1018330, 1 TAMPLIN ROAD, GUILDFORD

MMX-AR-0005

E FROZEN ARCHITECTURE SET

F FROZEN ARCHITECTURE SET

G FROZEN ARCHITECTURE SET

H FROZEN ARCHITECTURE SET


I DEVELOPMENT APPLICATON

DESCRIPTION

Report any discrepancies to the architect before carrying out any

03/07/2024

0m 1 2 3 4 5

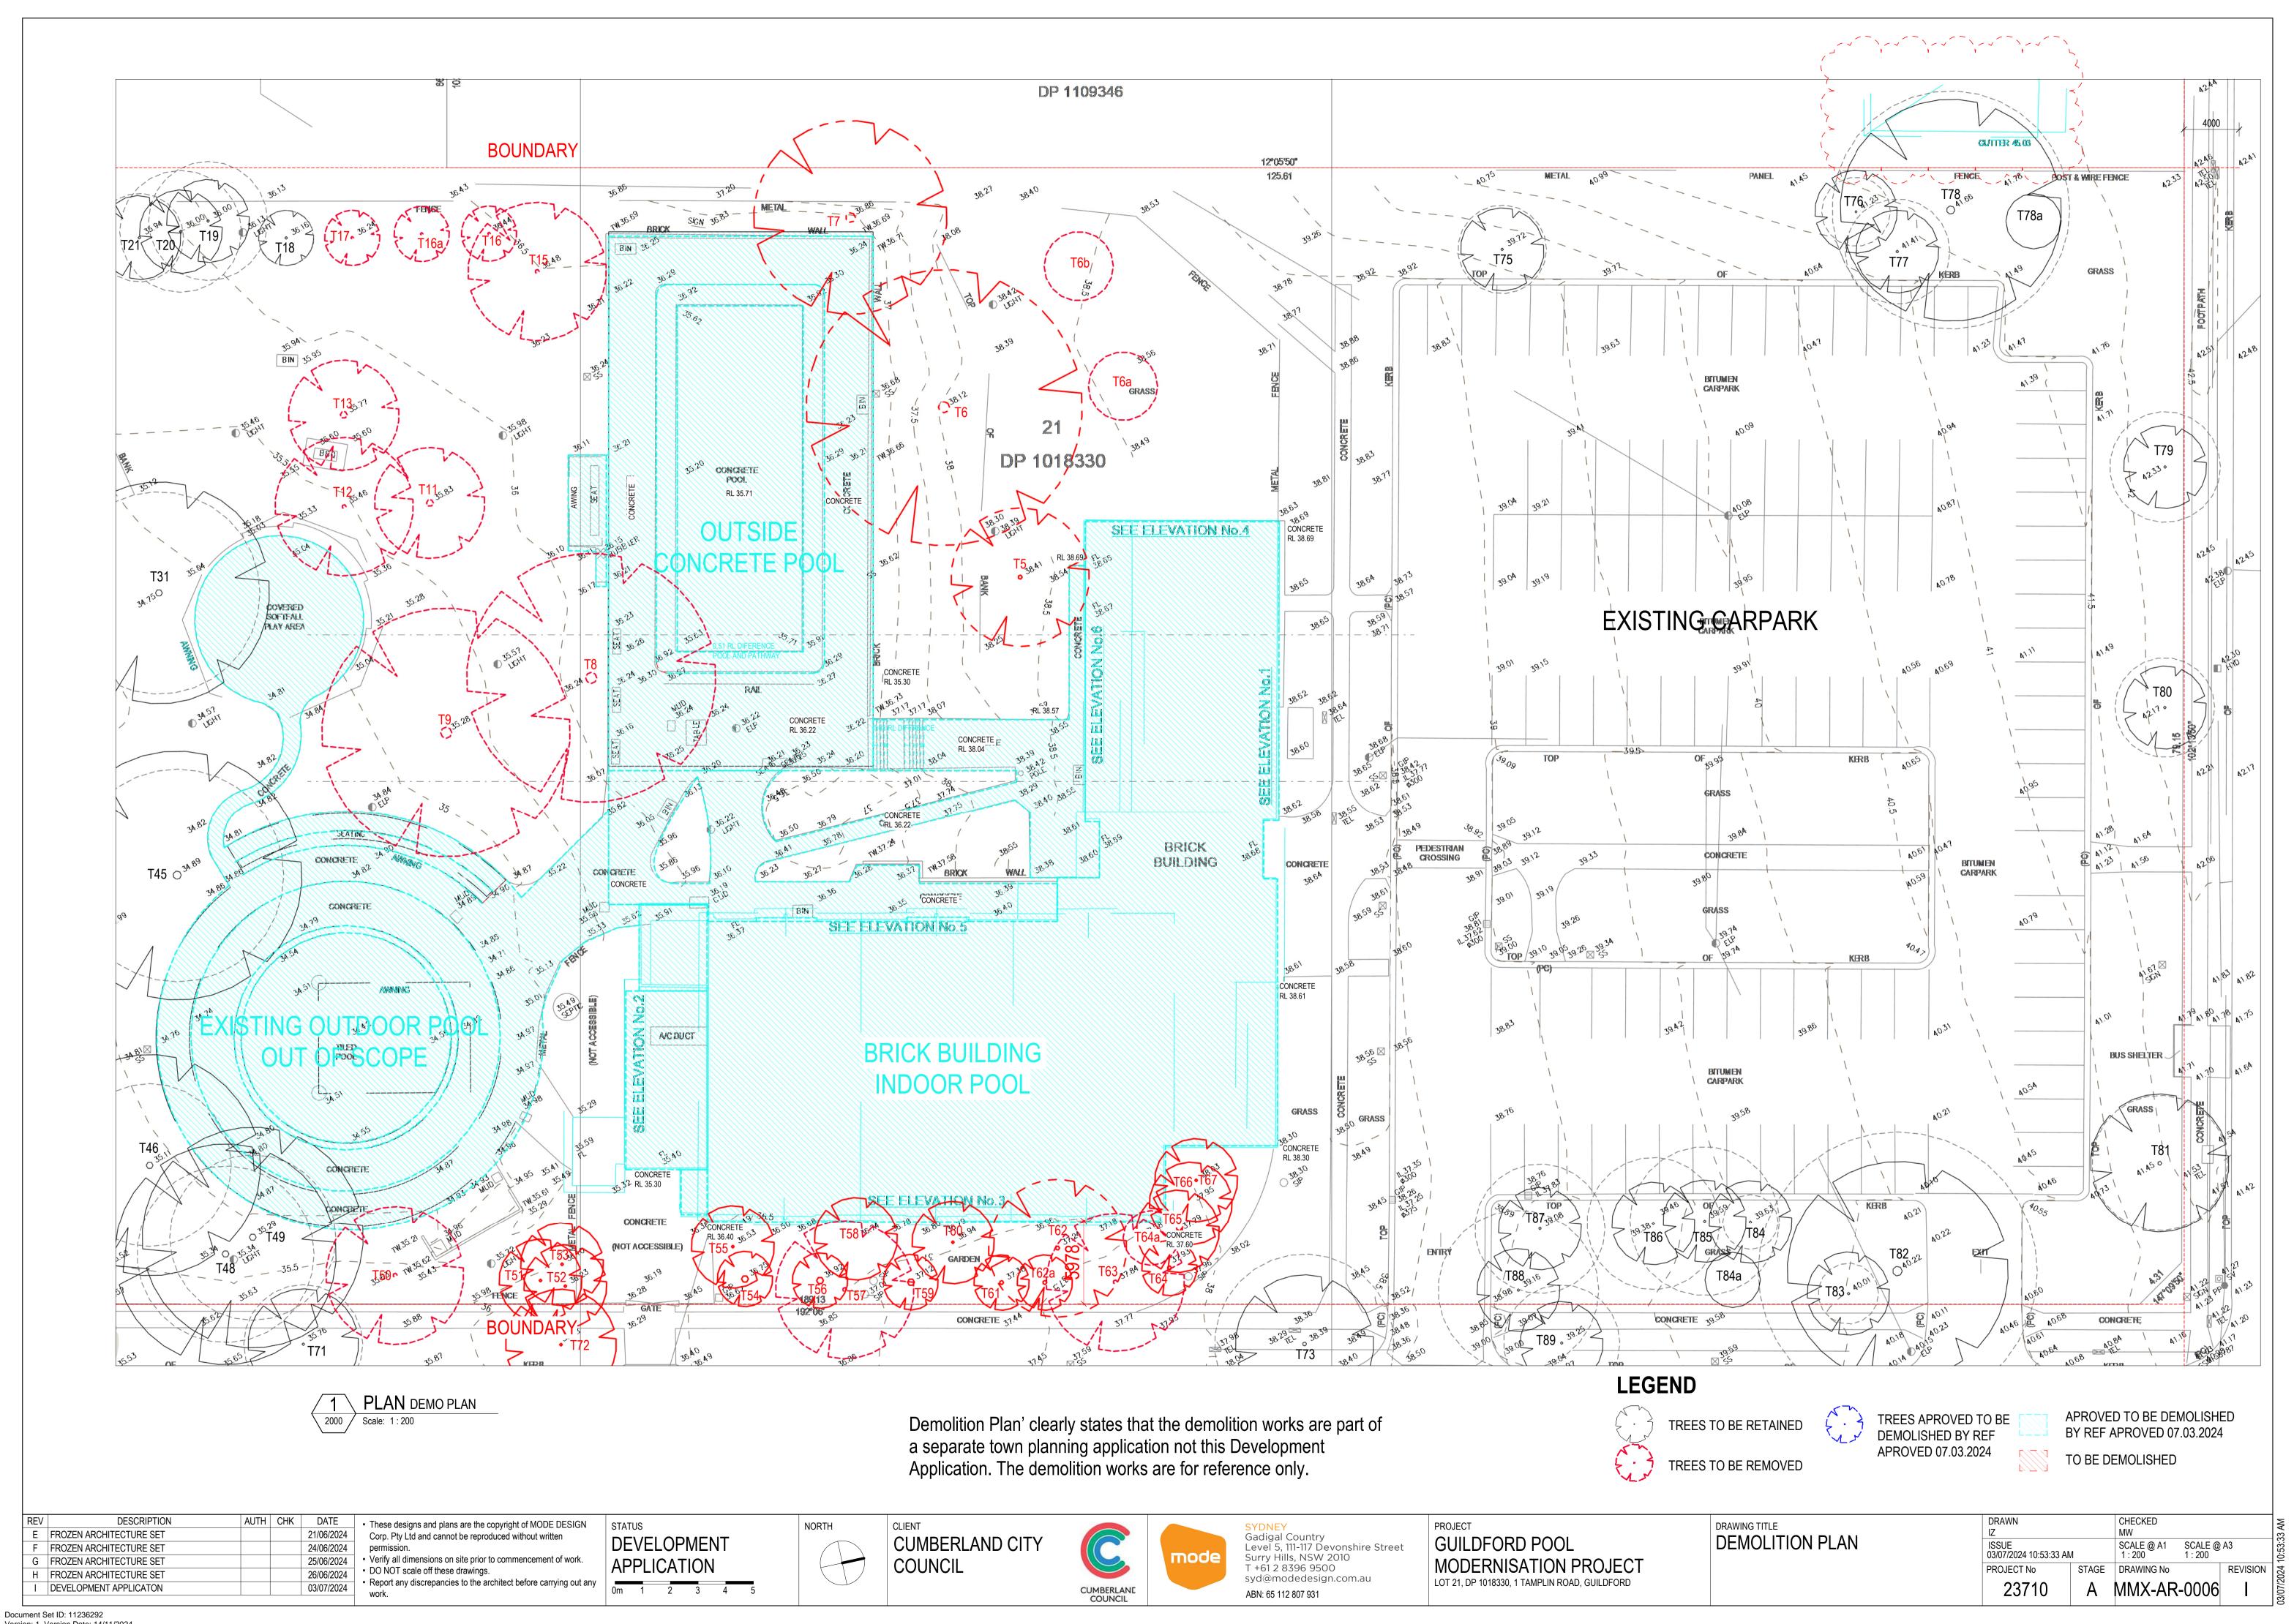



CONCEPT VIEW 01 - EAST

REV	DESCRIPTION	AUTH	CHK	DATE
Е	FROZEN ARCHITECTURE SET			21/06/2024
F	FROZEN ARCHITECTURE SET			24/06/2024
G	FROZEN ARCHITECTURE SET			25/06/2024
Н	FROZEN ARCHITECTURE SET			26/06/2024
	DEVELOPMENT APPLICATON			03/07/2024

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PROJECT
GUILDFORD POOL
MODERNISATION PROJECT
LOT 21, DP 1018330, 1 TAMPLIN ROAD, GUILDFORD

CONCEPT VIEW 01- EAST



REV DESCRIPTION AUTH CHK DATE

E FROZEN ARCHITECTURE SET 21/06/2024

F FROZEN ARCHITECTURE SET 24/06/2024

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25/06/2024

26/06/2024

03/07/2024

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DEVELOPMENT
APPLICATION
Om 1 2 3 4 5

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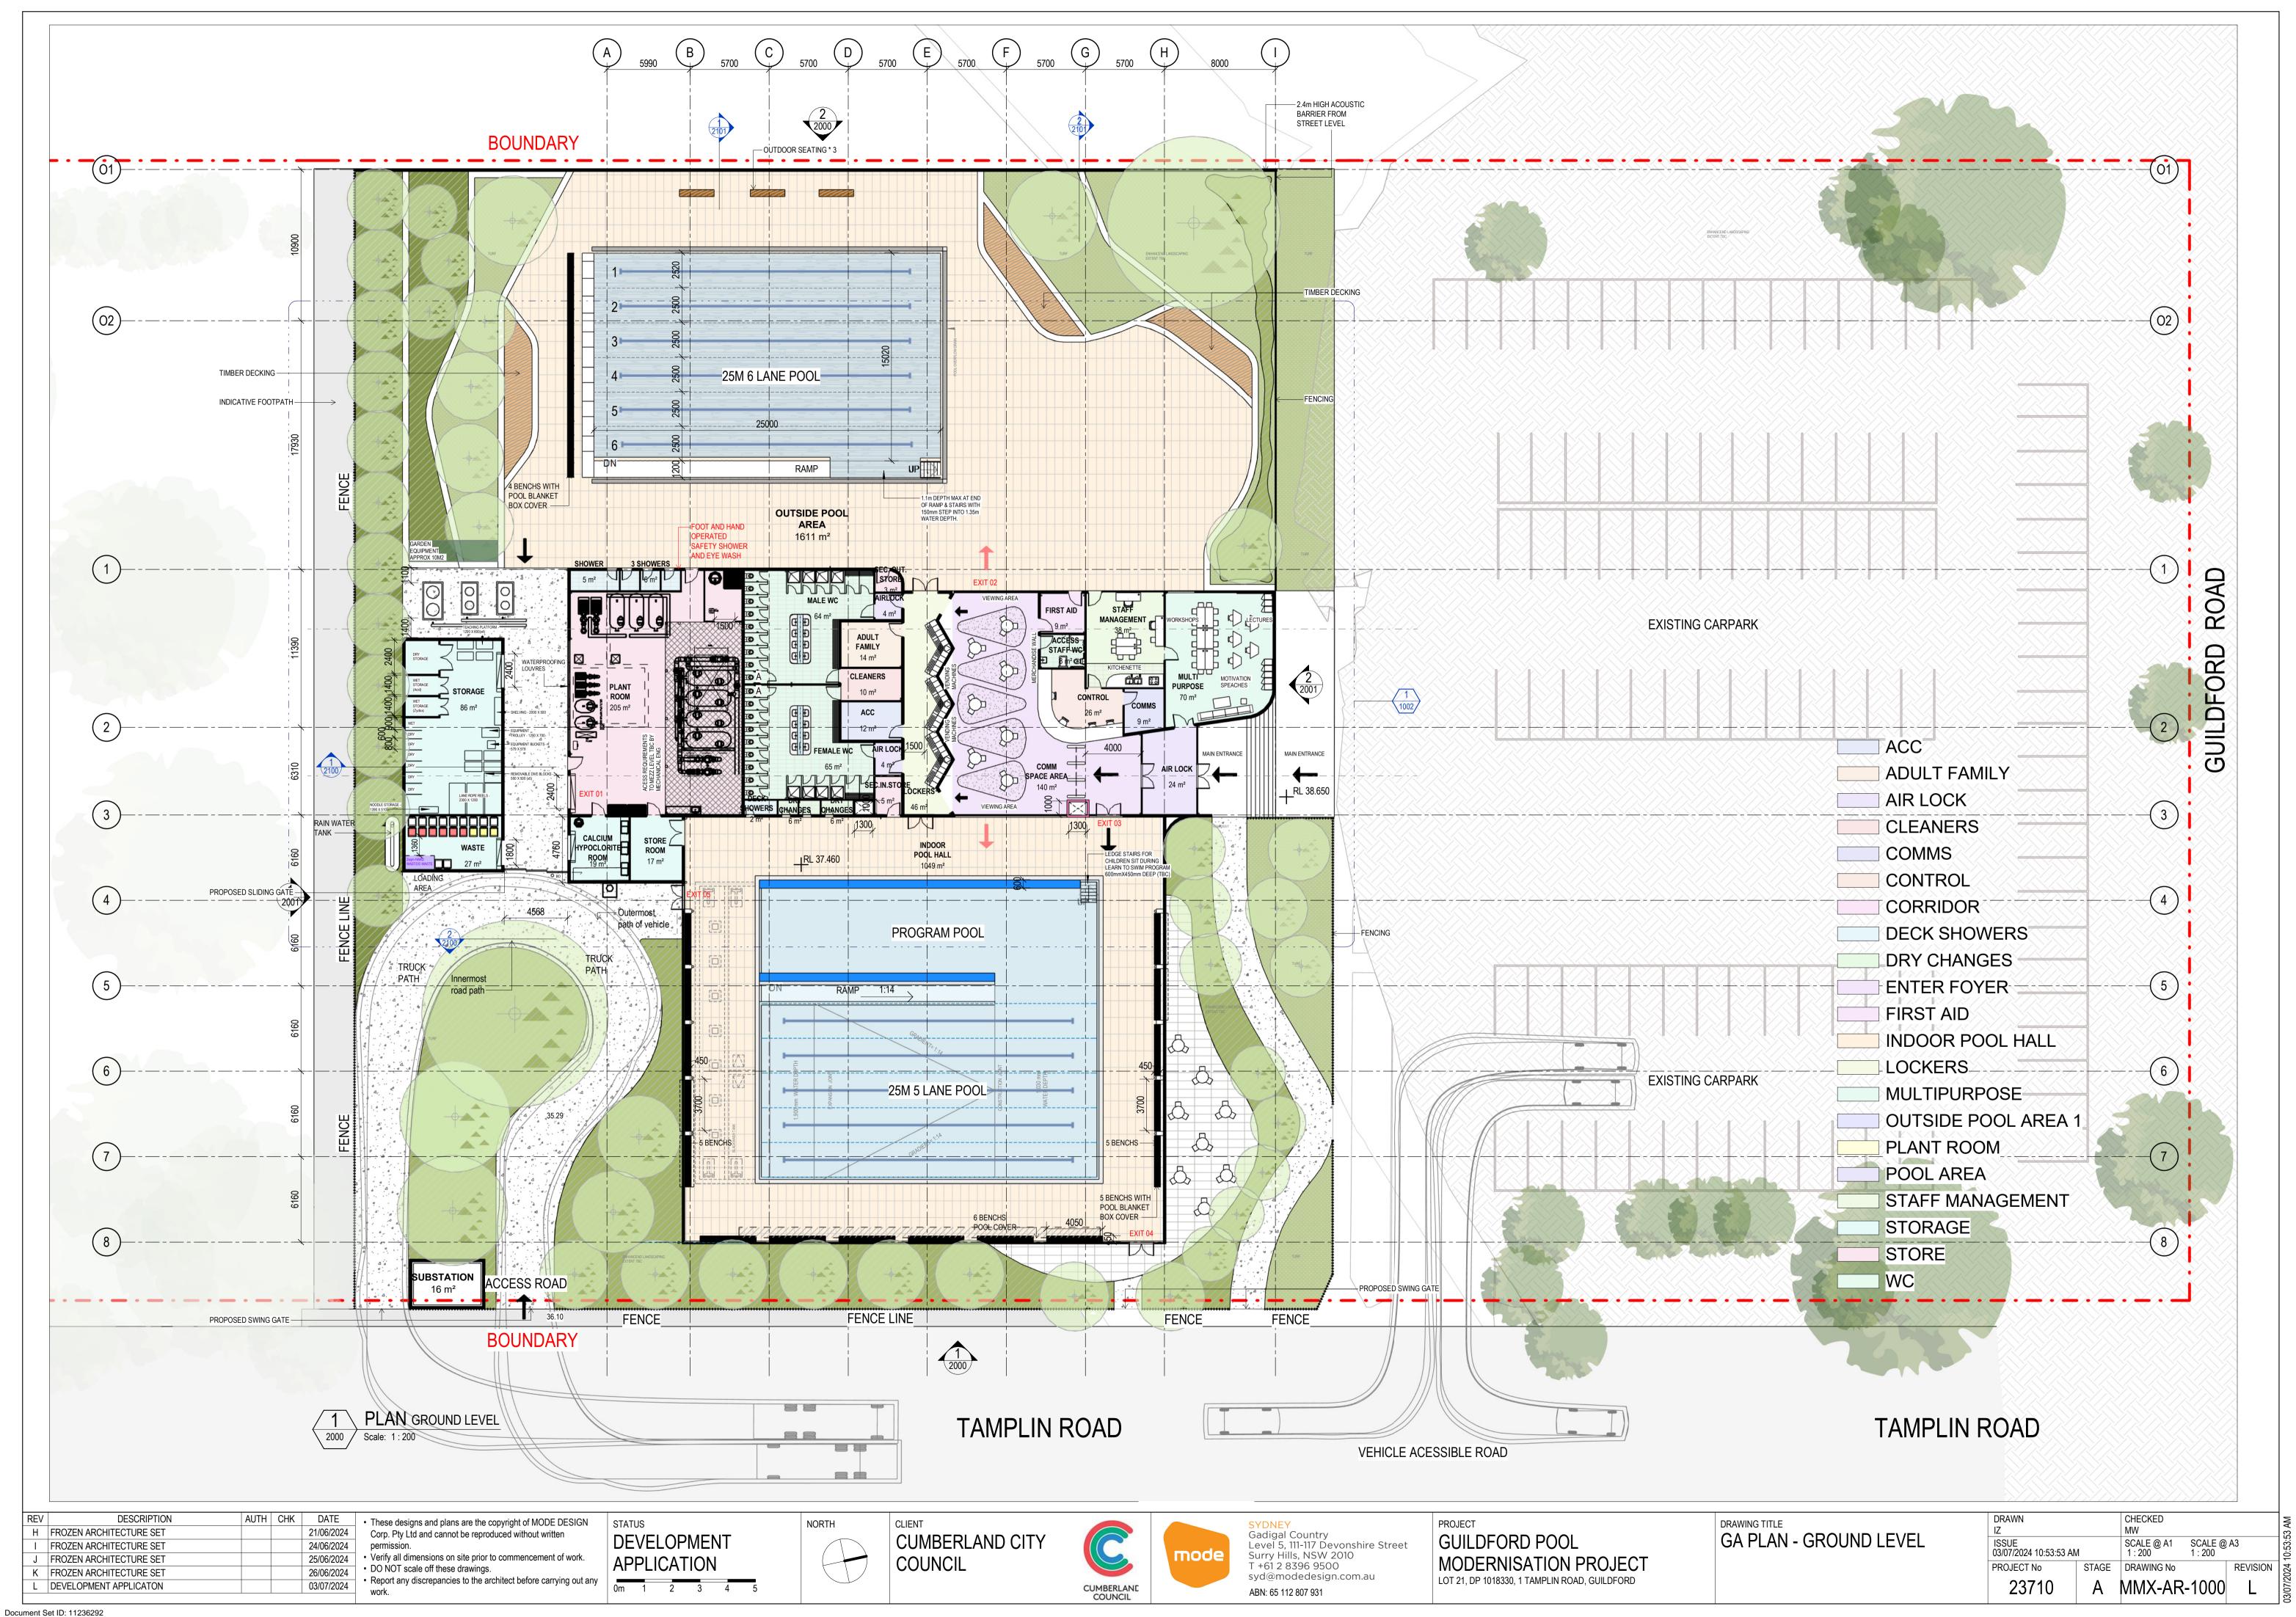
CONCEPT VIEW 02 - WEST


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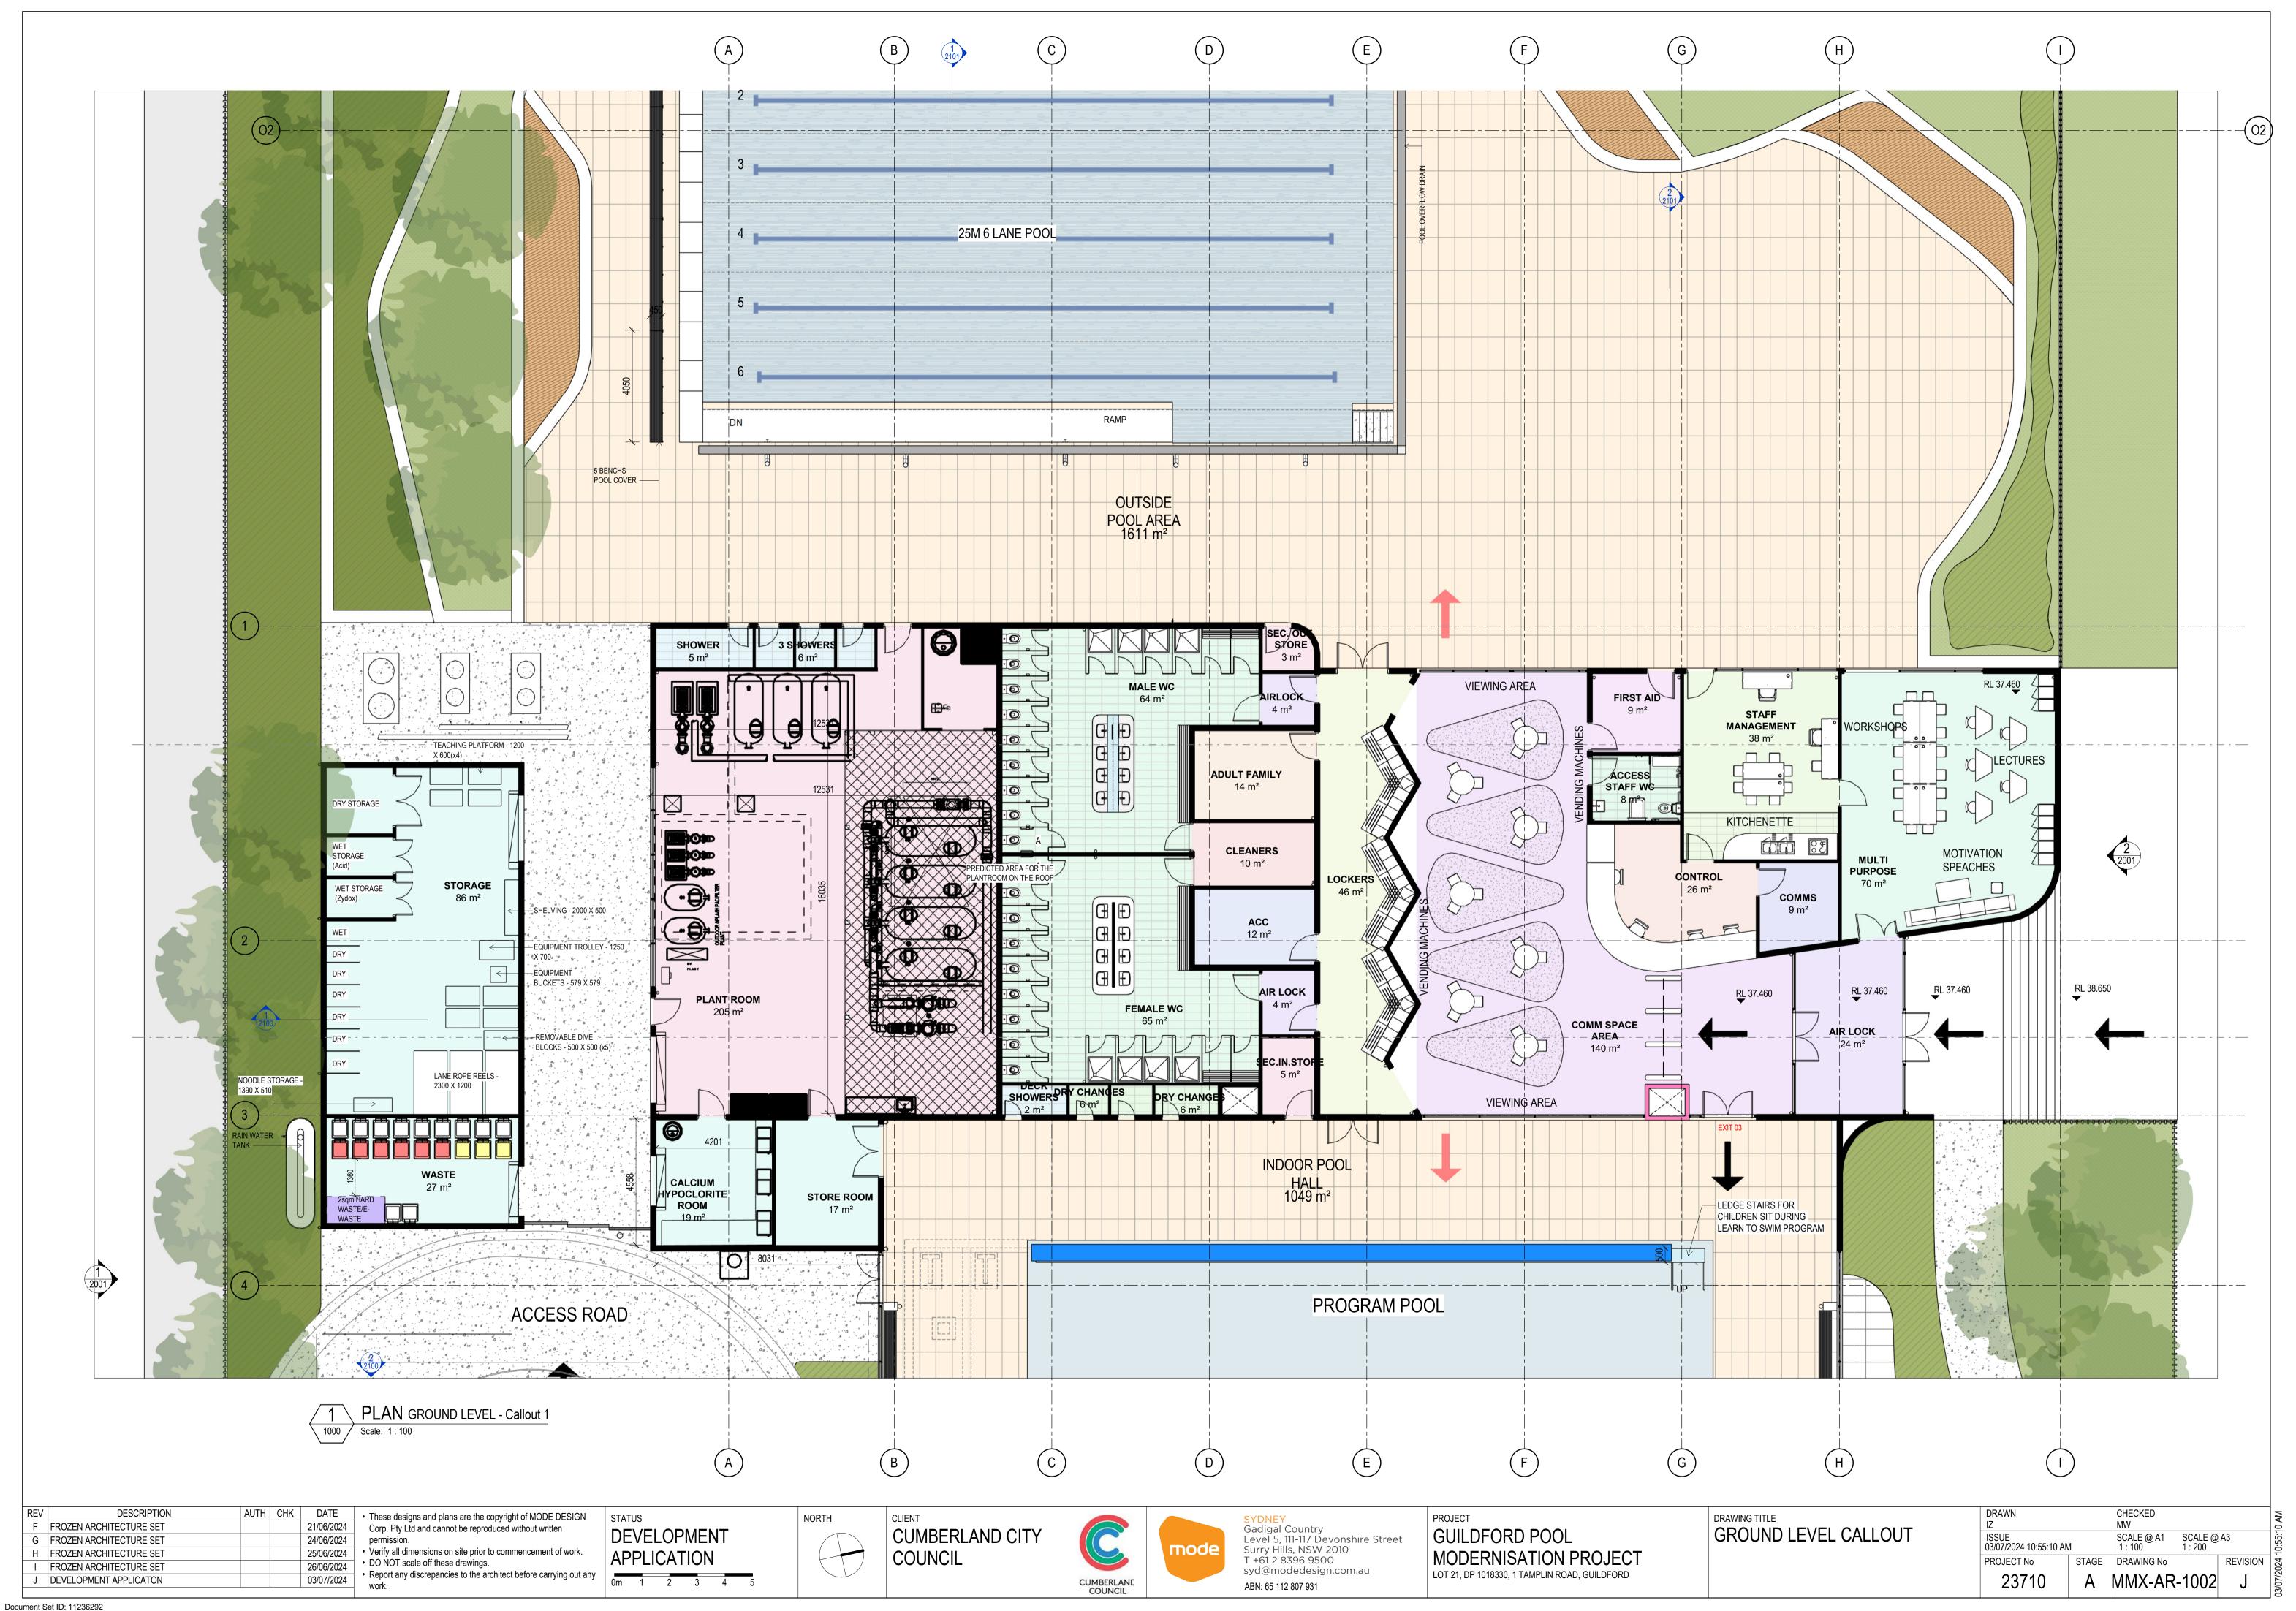
G FROZEN ARCHITECTURE SET


H FROZEN ARCHITECTURE SET

I DEVELOPMENT APPLICATON





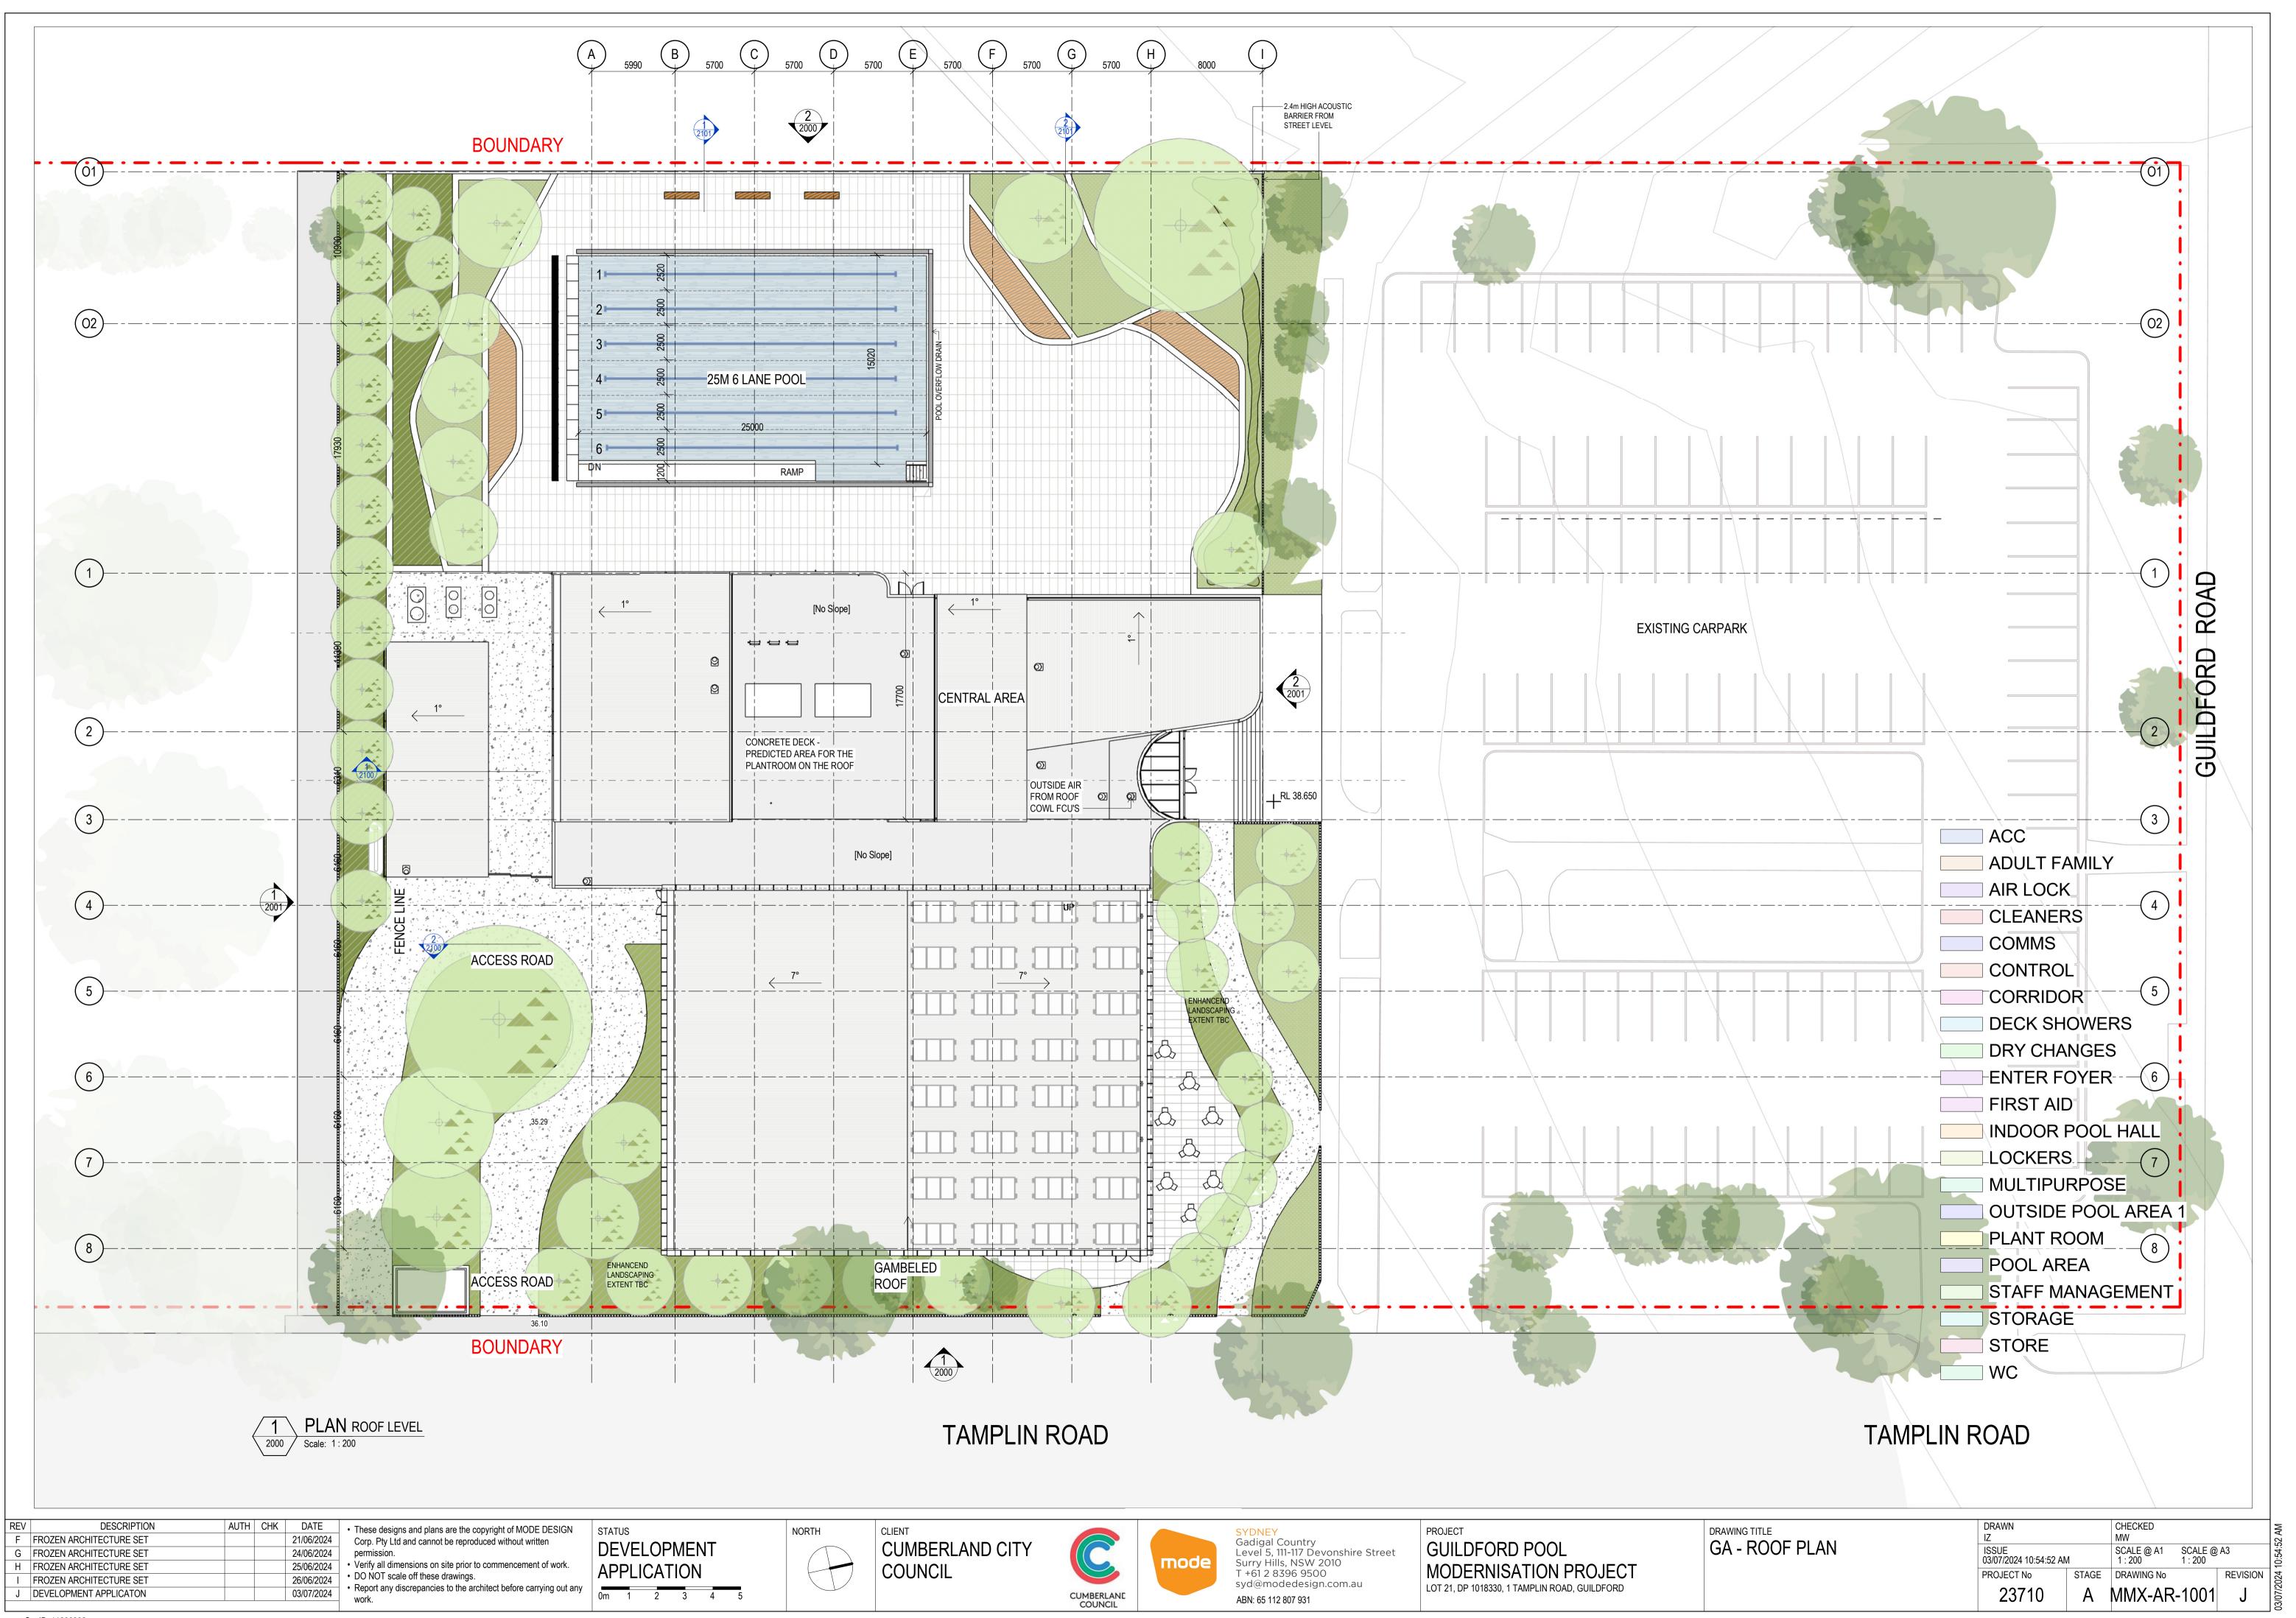

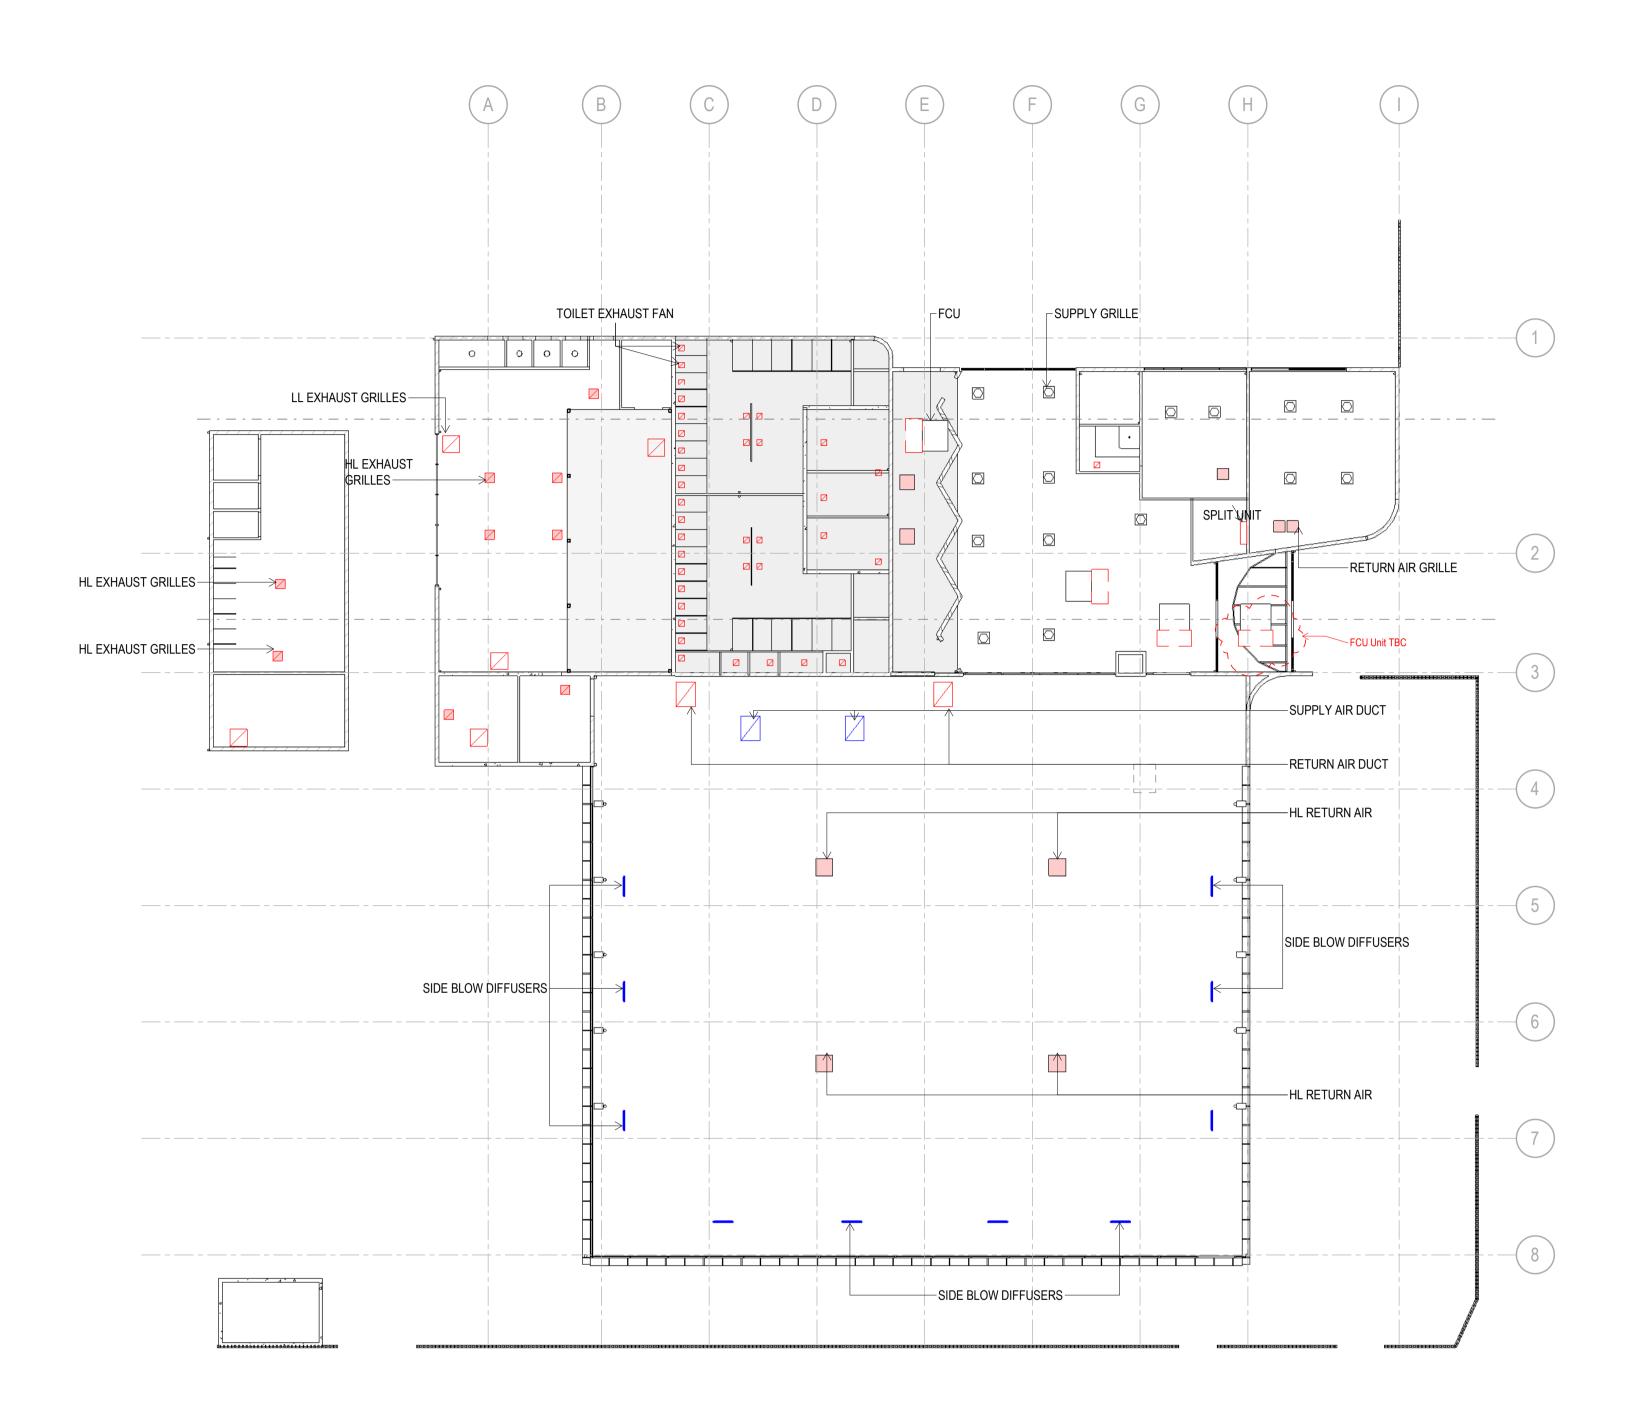

PLAN GROUND LEVEL1 - MECHANICAL LAYOUT Scale: 1:200

REV	DESCRIPTION	AUTH	CHK	DATE
F	FROZEN ARCHITECTURE SET			21/06/2024
G	FROZEN ARCHITECTURE SET			24/06/2024
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J	DEVELOPMENT APPLICATION			03/07/2024

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DEVELOPMENT APPLICATION NORTH

CUMBERLAND CITY COUNCIL





PROJECT
GUILDFORD POOL
MODERNISATION PROJECT
LOT 21, DP 1018330, 1 TAMPLIN ROAD, GUILDFORD

MECHANICAL LAYOUT - GROUND LEVEL

PRELIMINARY ONLY - TBC

MECHANICAL, HYDRAULIC AND ELECTRICAL NOTES

FIRE HYDRANTS VALVE HEIGHT MUST BE 900MM.

MAKING SAFE ALL ELECTRICAL INSTALLATION

CAN BE CONNECTED.


SELF CLOSING DAMPER

ALL SERVICES MUST REMAIN ACTIVE, MINIMISE ANY DISRUPTIONS.
REFER TO ELECTRICAL AND MECHANICAL DRAWINGS FOR DETAILS
ALLOW TO CUT HYDRAULIC PIPING SUCH THAT THE NEW FIXTURES

 THE ELECTRICAL CONTRACTOR SHALL MAKE ALLOWANCE FOR CHASE WALLS FOR POWER CONNECTIONS, DISCONNECTION AND

ALL EXHAUST FANS TO BE FIT WITH A SEALING DEVICE SUCH AS A

): 11236292

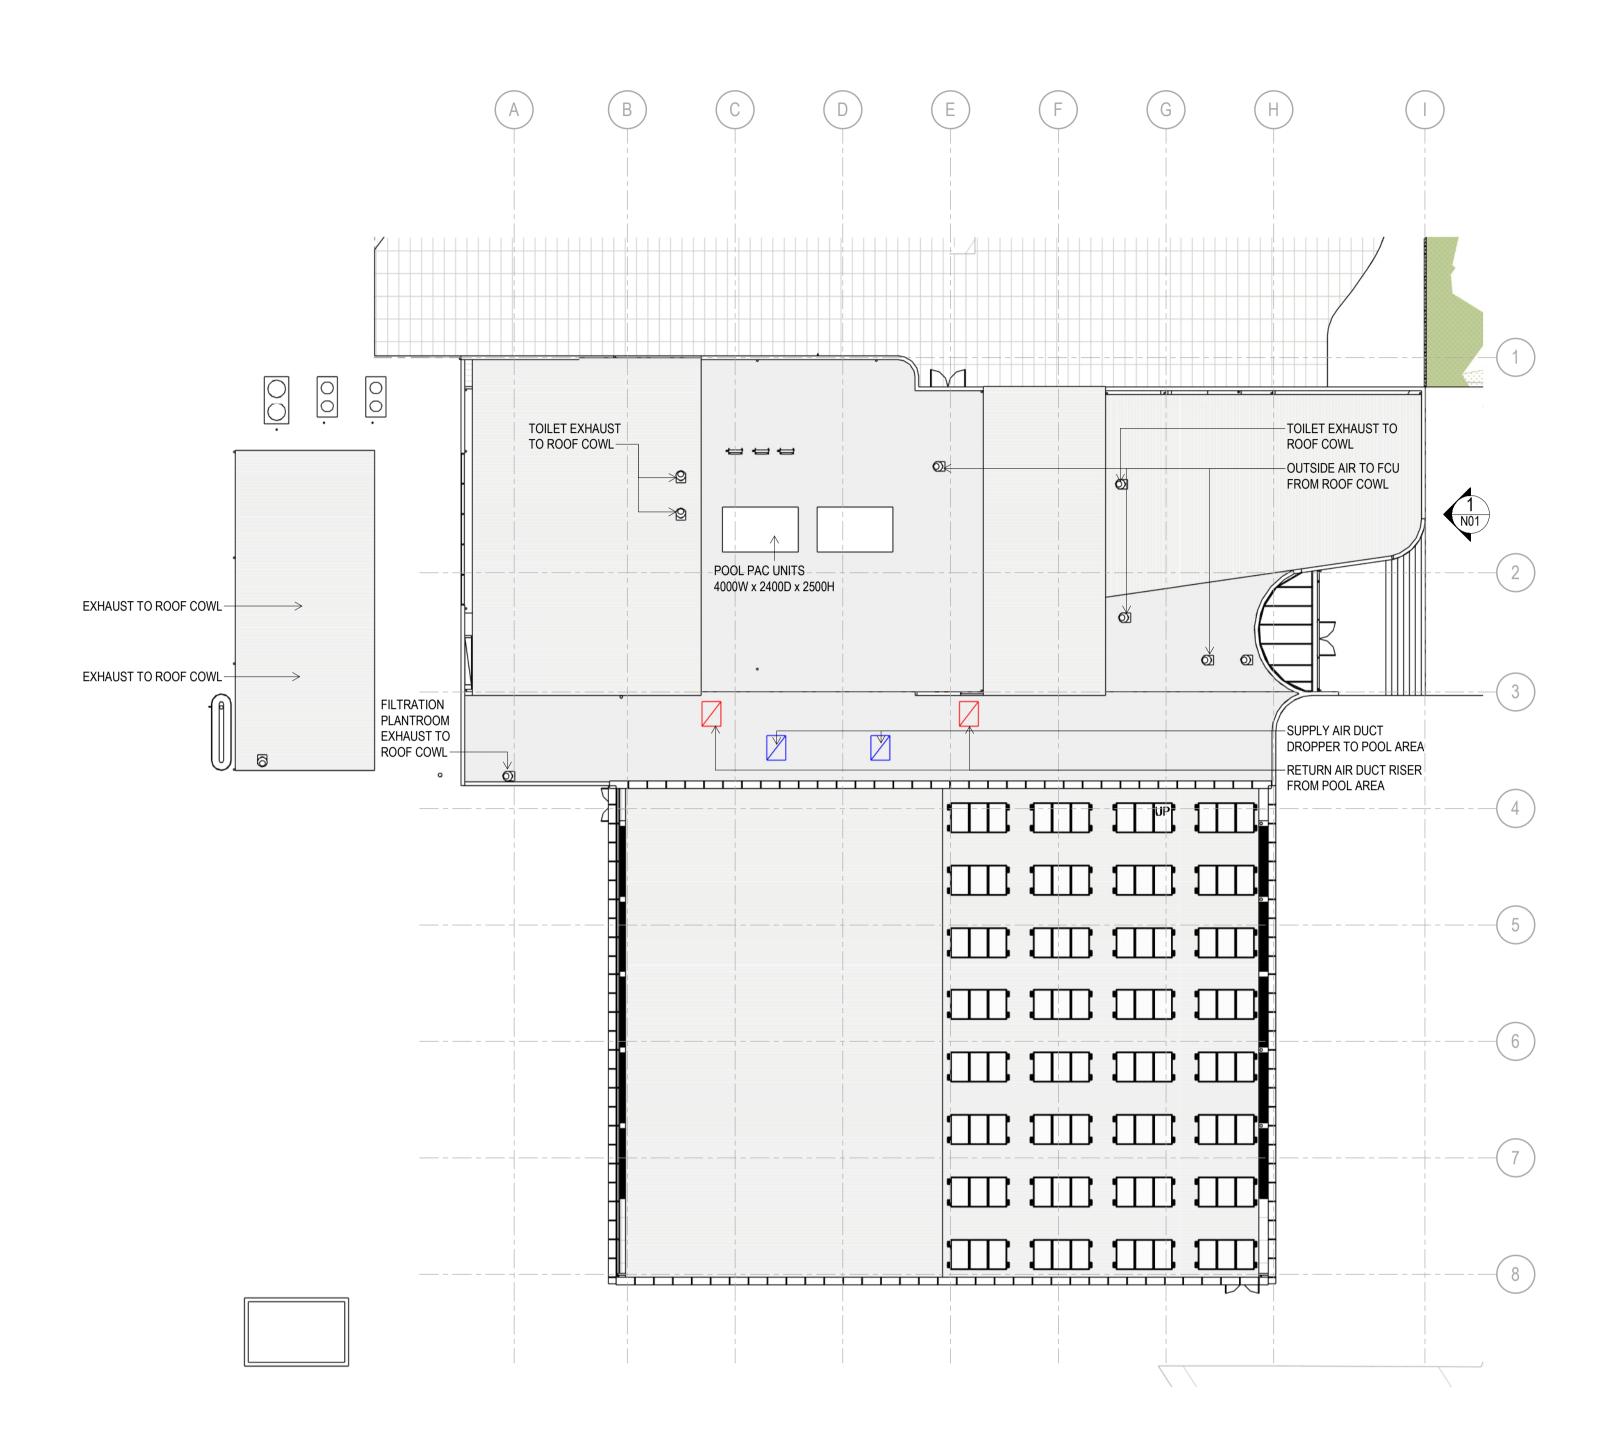

PLAN ROOF LEVEL MECHANICAL Scale: 1:200

DO NOT scale off these drawings.


REV	DESCRIPTION	AUTH	CHK	DATE
F	FROZEN ARCHITECTURE SET			21/06/2024
G	FROZEN ARCHITECTURE SET			24/06/2024
Н	FROZEN ARCHITECTURE SET			25/06/2024
I	FROZEN ARCHITECTURE SET			26/06/2024
J	DEVELOPMENT APPLICATION			03/07/2024

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DEVELOPMENT APPLICATION 0m 1 2 3 4 5

STATUS



CUMBERLAND CITY
COUNCIL

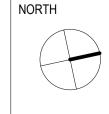





GUILDFORD POOL
MODERNISATION PROJECT
LOT 21, DP 1018330, 1 TAMPLIN ROAD, GUILDFORD

MECHANICAL LAYOUT - ROOF LEVEL

MECHANICAL, HYDRAULIC AND ELECTRICAL NOTES

FIRE HYDRANTS VALVE HEIGHT MUST BE 900MM.

MAKING SAFE ALL ELECTRICAL INSTALLATION

CAN BE CONNECTED.


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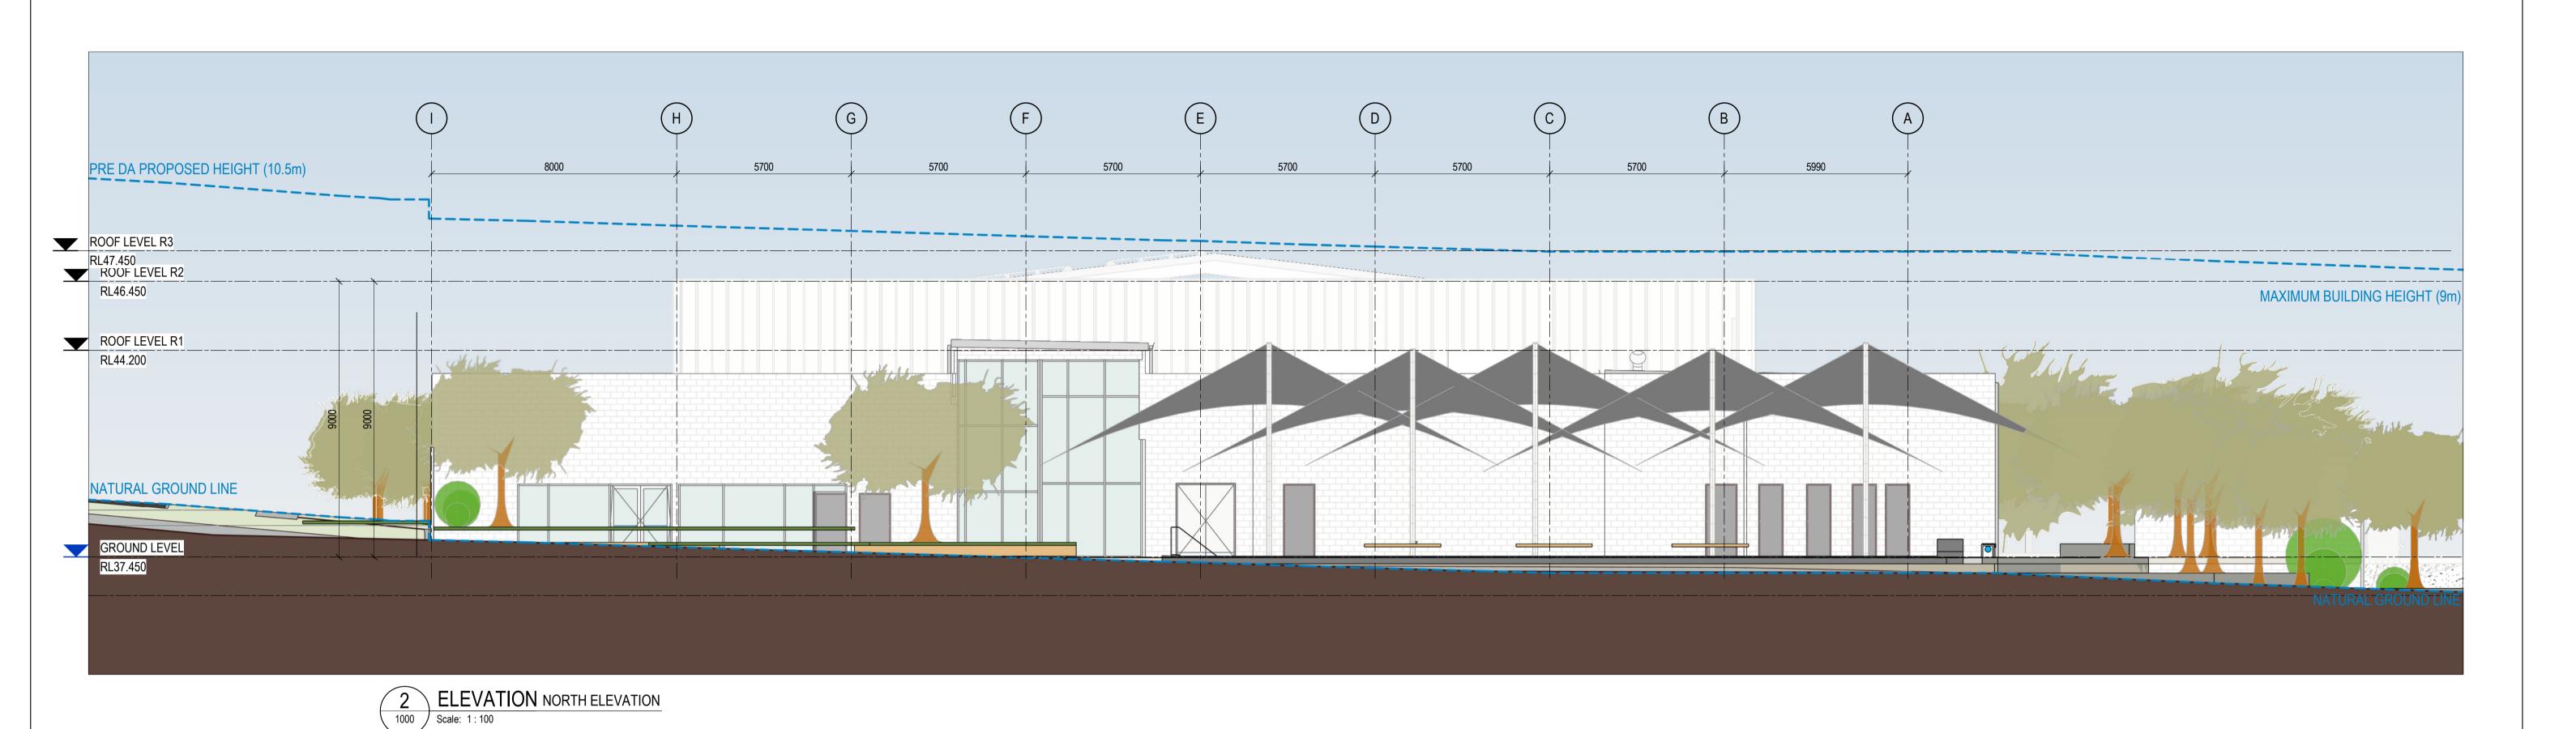
ALL SERVICES MUST REMAIN ACTIVE, MINIMISE ANY DISRUPTIONS.
 REFER TO ELECTRICAL AND MECHANICAL DRAWINGS FOR DETAILS
 ALLOW TO CUT HYDRAULIC PIPING SUCH THAT THE NEW FIXTURES


THE ELECTRICAL CONTRACTOR SHALL MAKE ALLOWANCE FOR

ALL EXHAUST FANS TO BE FIT WITH A SEALING DEVICE SUCH AS A

CHASE WALLS FOR POWER CONNECTIONS, DISCONNECTION AND




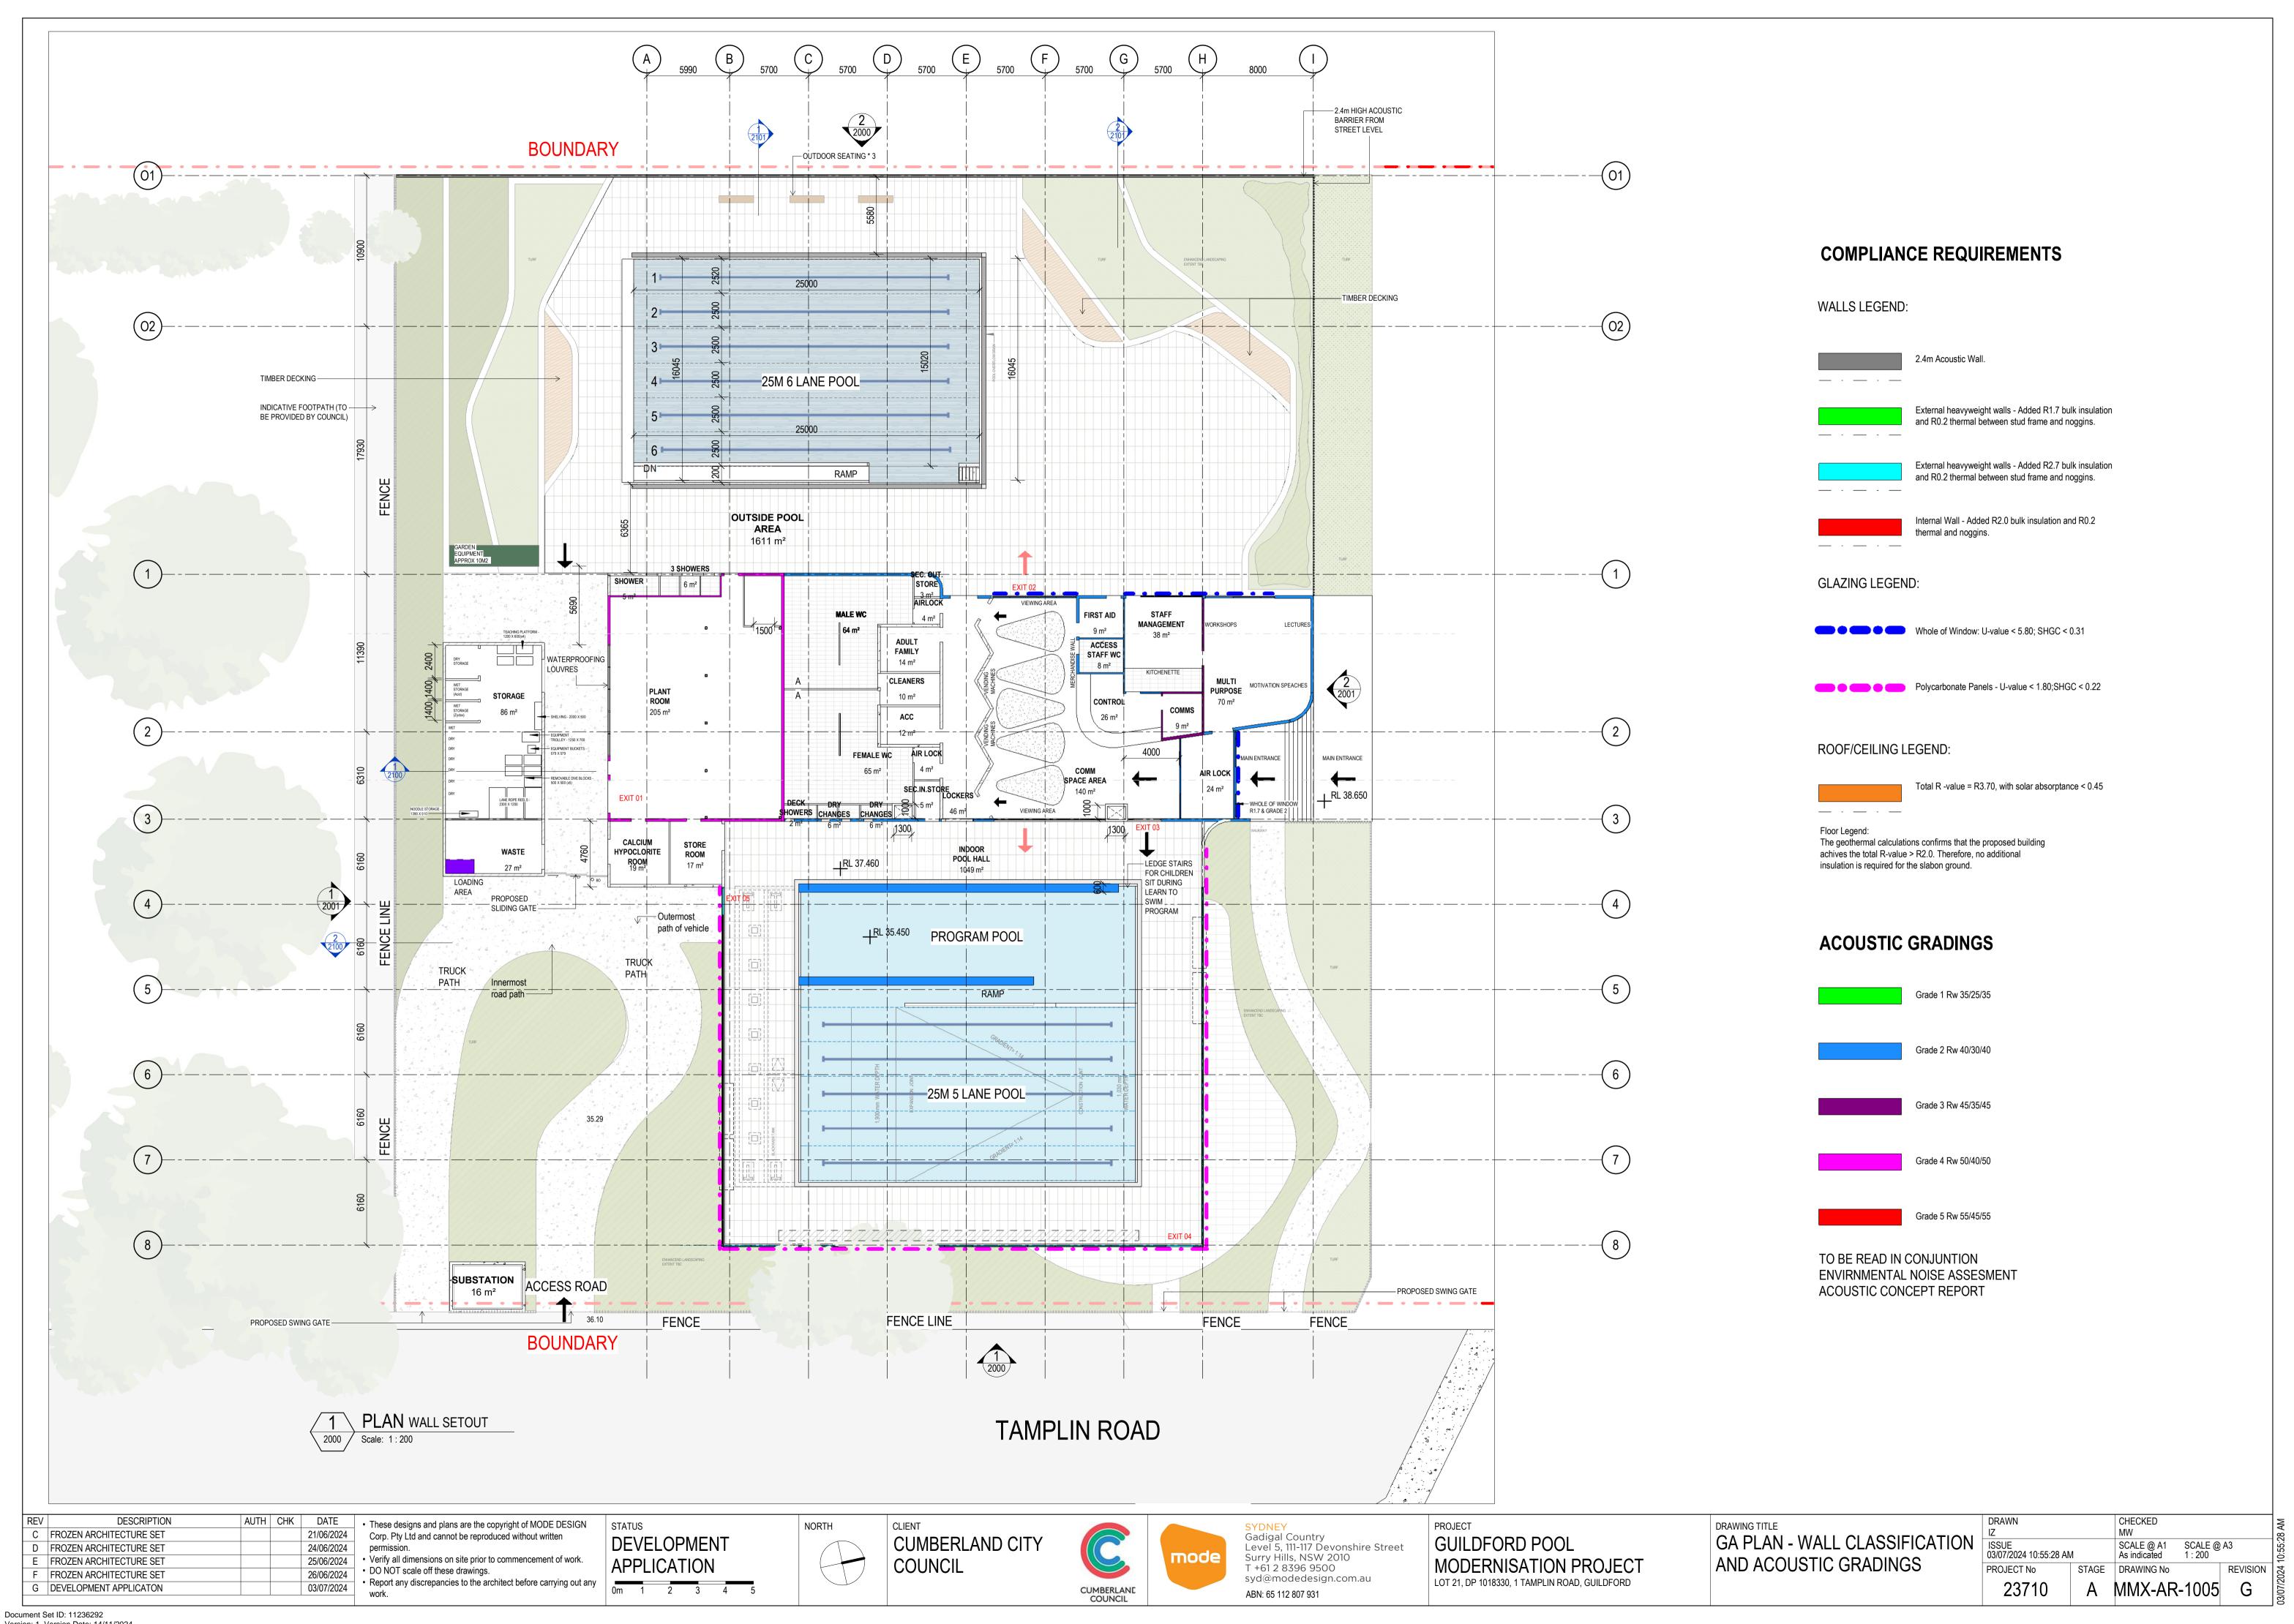

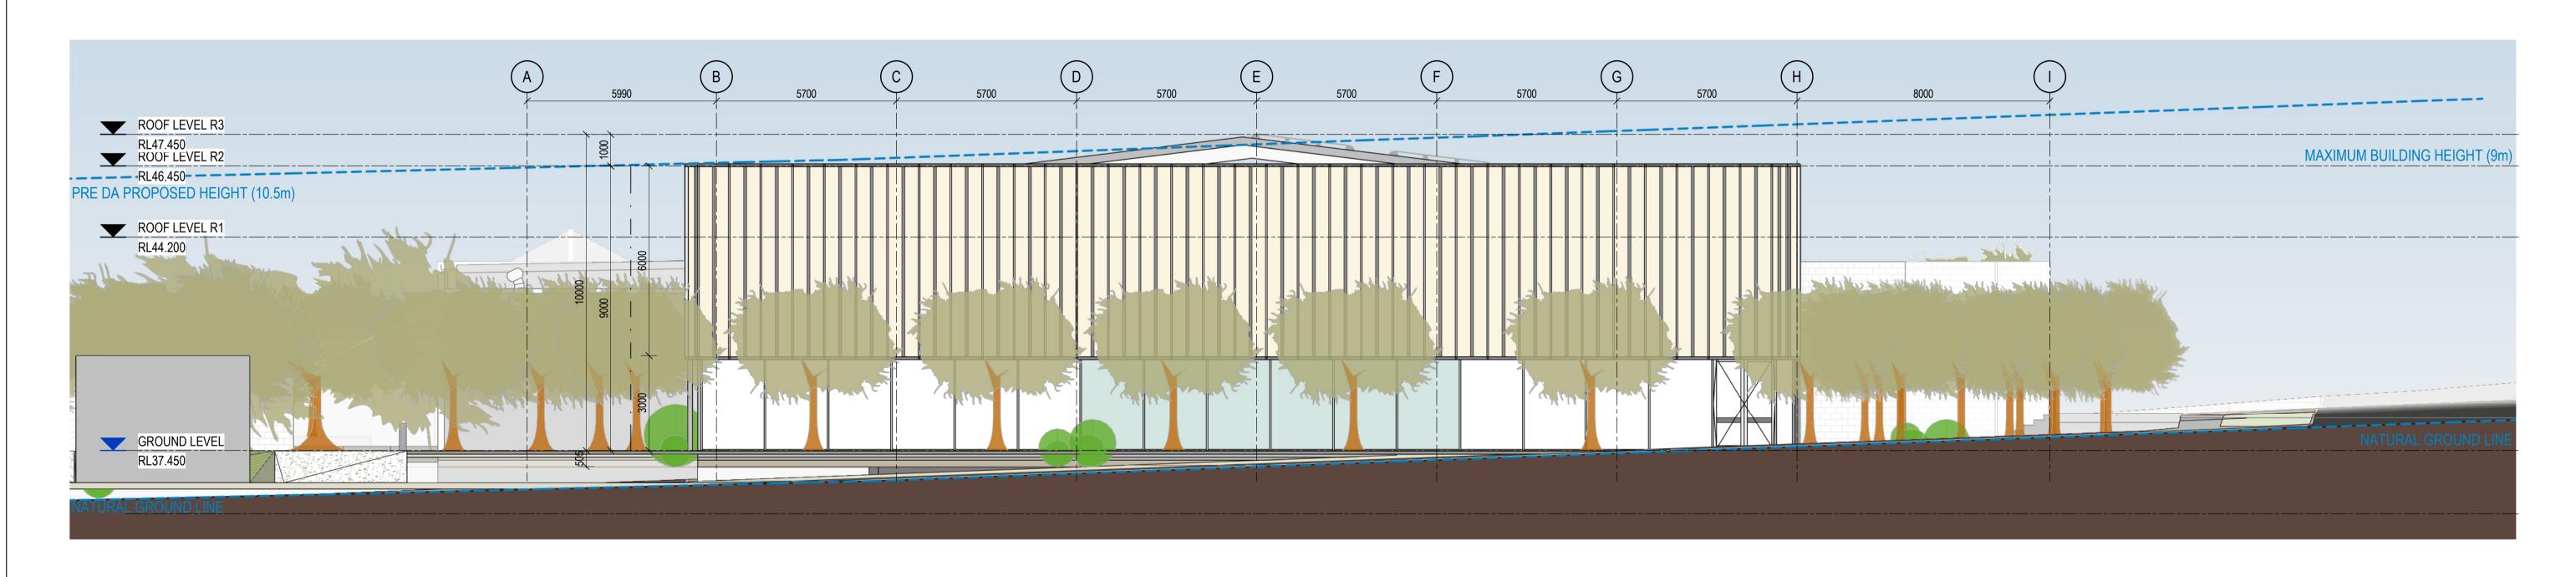


1 ELEVATION SOUTH ELEVATION
Scale: 1:100

AUTH CHK DATE CHECKED MW DESCRIPTION These designs and plans are the copyright of MODE DESIGN Corp. Pty Ltd and cannot be reproduced without written STATUS SYDNEY
Gadigal Country
Level 5, 111-117 Devonshire Street
Surry Hills, NSW 2010 PROJECT DRAWING TITLE F FROZEN ARCHITECTURE SET 21/06/2024 **ELEVATIONS NORTH & SOUTH** DEVELOPMENT **CUMBERLAND CITY GUILDFORD POOL** ISSUE 03/07/2024 10:57:05 AM SCALE @ A1 1:100 24/06/2024 G FROZEN ARCHITECTURE SET H FROZEN ARCHITECTURE SET 25/06/2024 • Verify all dimensions on site prior to commencement of work. APPLICATION COUNCIL **MODERNISATION PROJECT** T +61 2 8396 9500 PROJECT No STAGE DRAWING No REVISION 2 DO NOT scale off these drawings. I FROZEN ARCHITECTURE SET 26/06/2024 syd@modedesign.com.au • Report any discrepancies to the architect before carrying out any LOT 21, DP 1018330, 1 TAMPLIN ROAD, GUILDFORD 0m 1 2 3 4 5 A MMX-AR-2000 J DEVELOPMENT APPLICATION 03/07/2024 CUMBERLANE COUNCIL ABN: 65 112 807 931

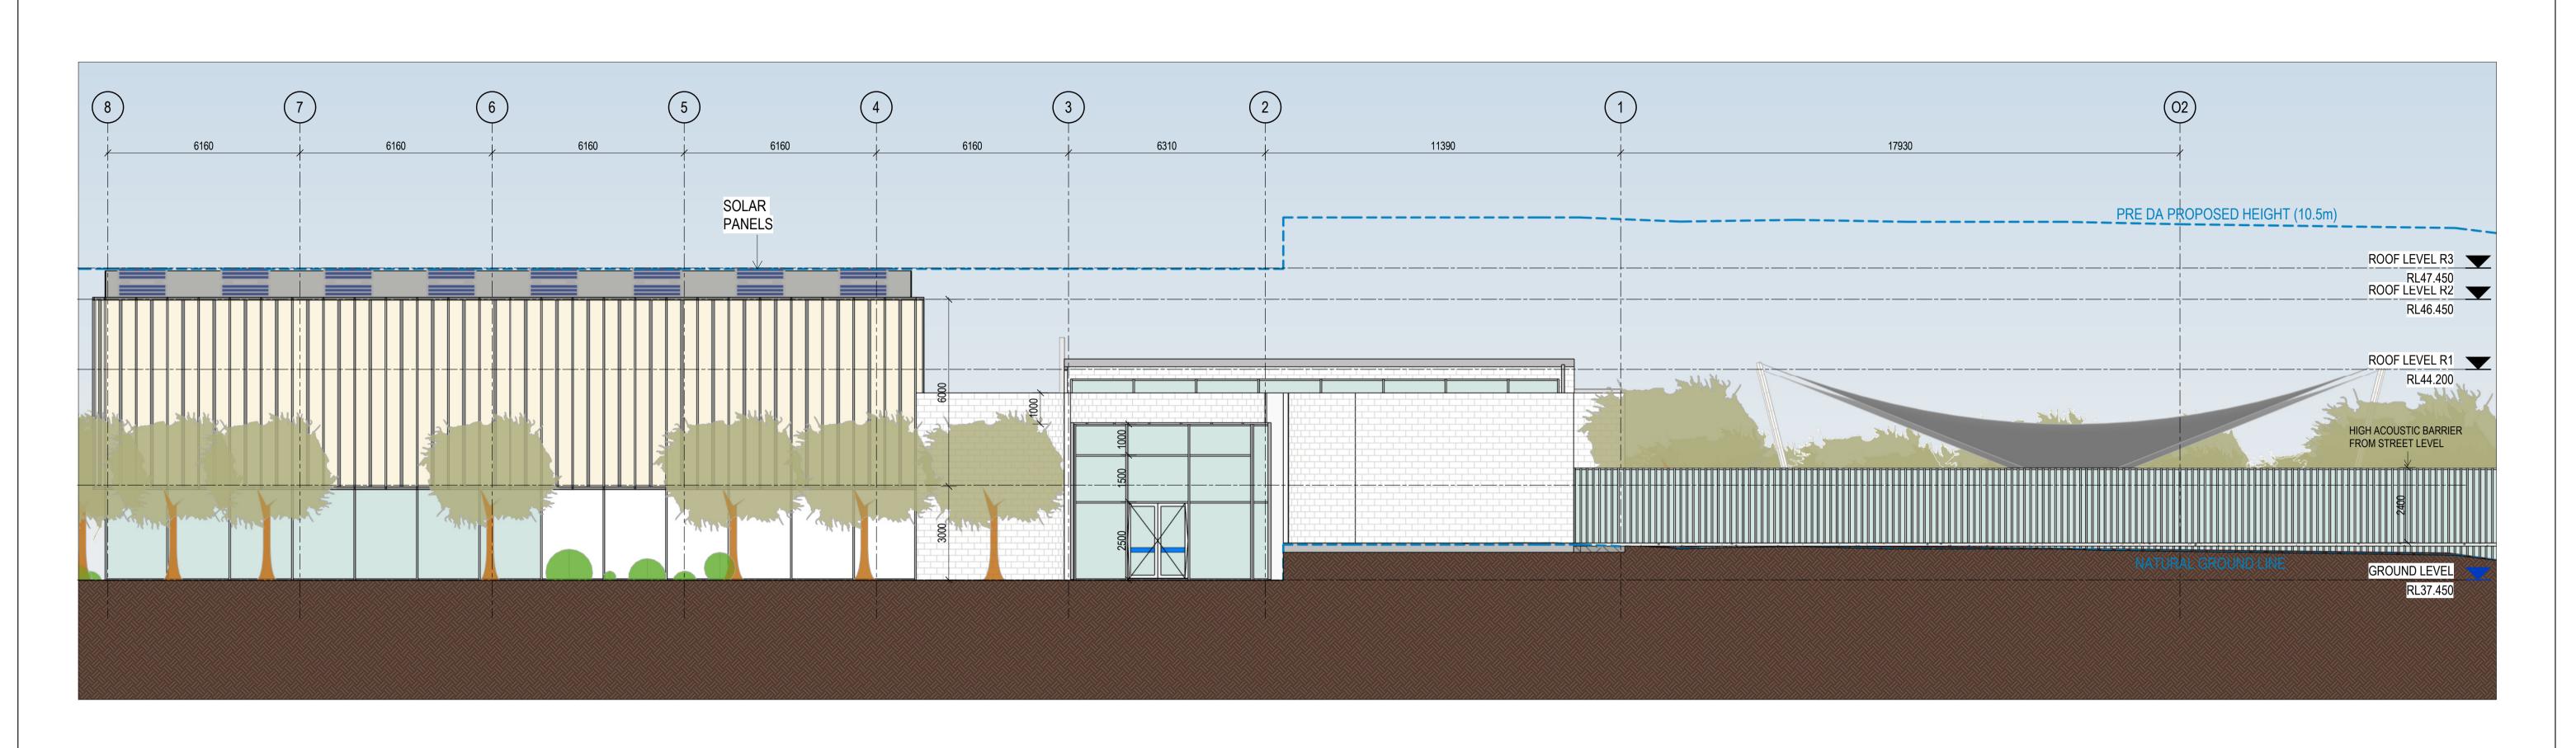



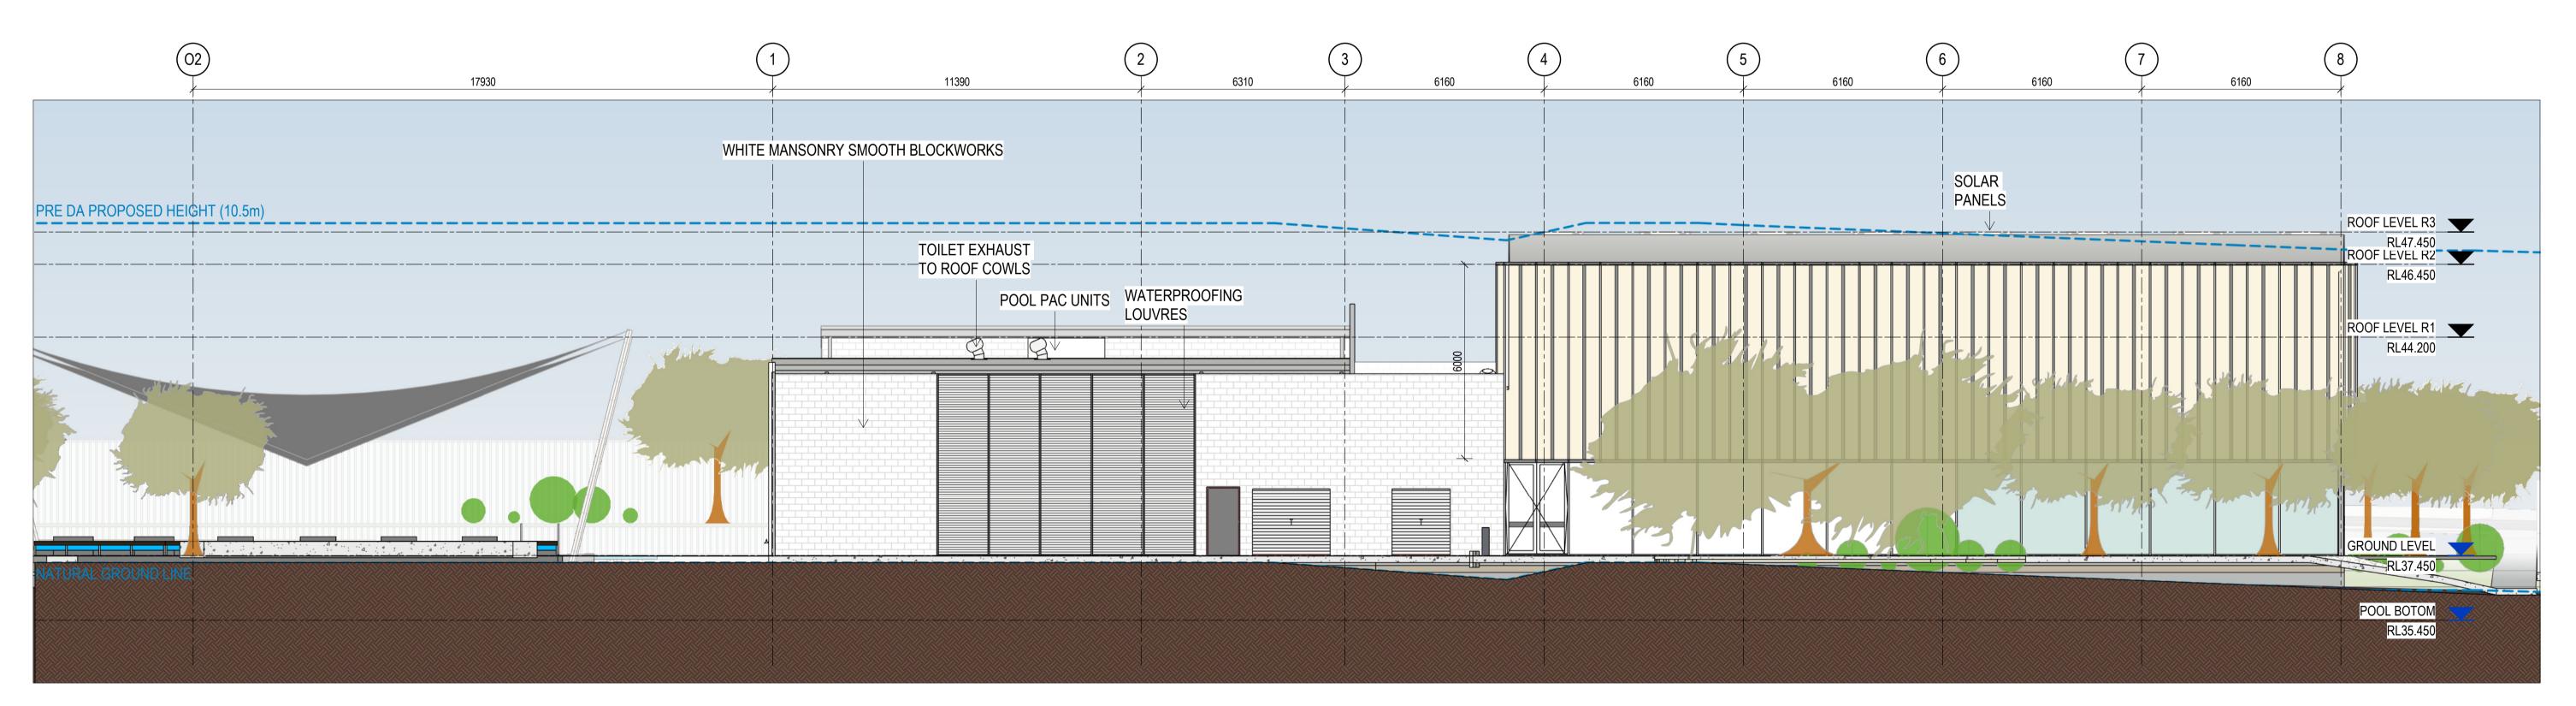

1 ELEVATION WEST ELEVATION
Scale: 1:100

I	REV	DESCRIPTION	AUTH	CHK	DATE
I	F	FROZEN ARCHITECTURE SET			21/06/20
I	G	FROZEN ARCHITECTURE SET			24/06/20
I	Н	FROZEN ARCHITECTURE SET			25/06/20
I	I	FROZEN ARCHITECTURE SET			26/06/20
I	J	DEVELOPMENT APPLICATION		·	03/07/20

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APPLICATION
Om 1 2 3 4 5

CUMBERLAND CITY
COUNCIL



SYDNEY
Gadigal Country
Level 5, 111-117 Devonshire Street
Surry Hills, NSW 2010
T +61 2 8396 9500
syd@modedesign.com.au
ABN: 65 112 807 931


PROJECT
GUILDFORD POOL
MODERNISATION PROJECT
LOT 21, DP 1018330, 1 TAMPLIN ROAD, GUILDFORD

ELEVATIONS EAST & WEST

| DRAWN | IZ | MW | SCALE @ A1 | 1 : 100 | PROJECT No | STAGE | DRAWING No | REVISION | J | STAGE | DRAWING No | DRAWING No | CAN | DRAWING No | DRA



SECTION SHORT SECTION A-A

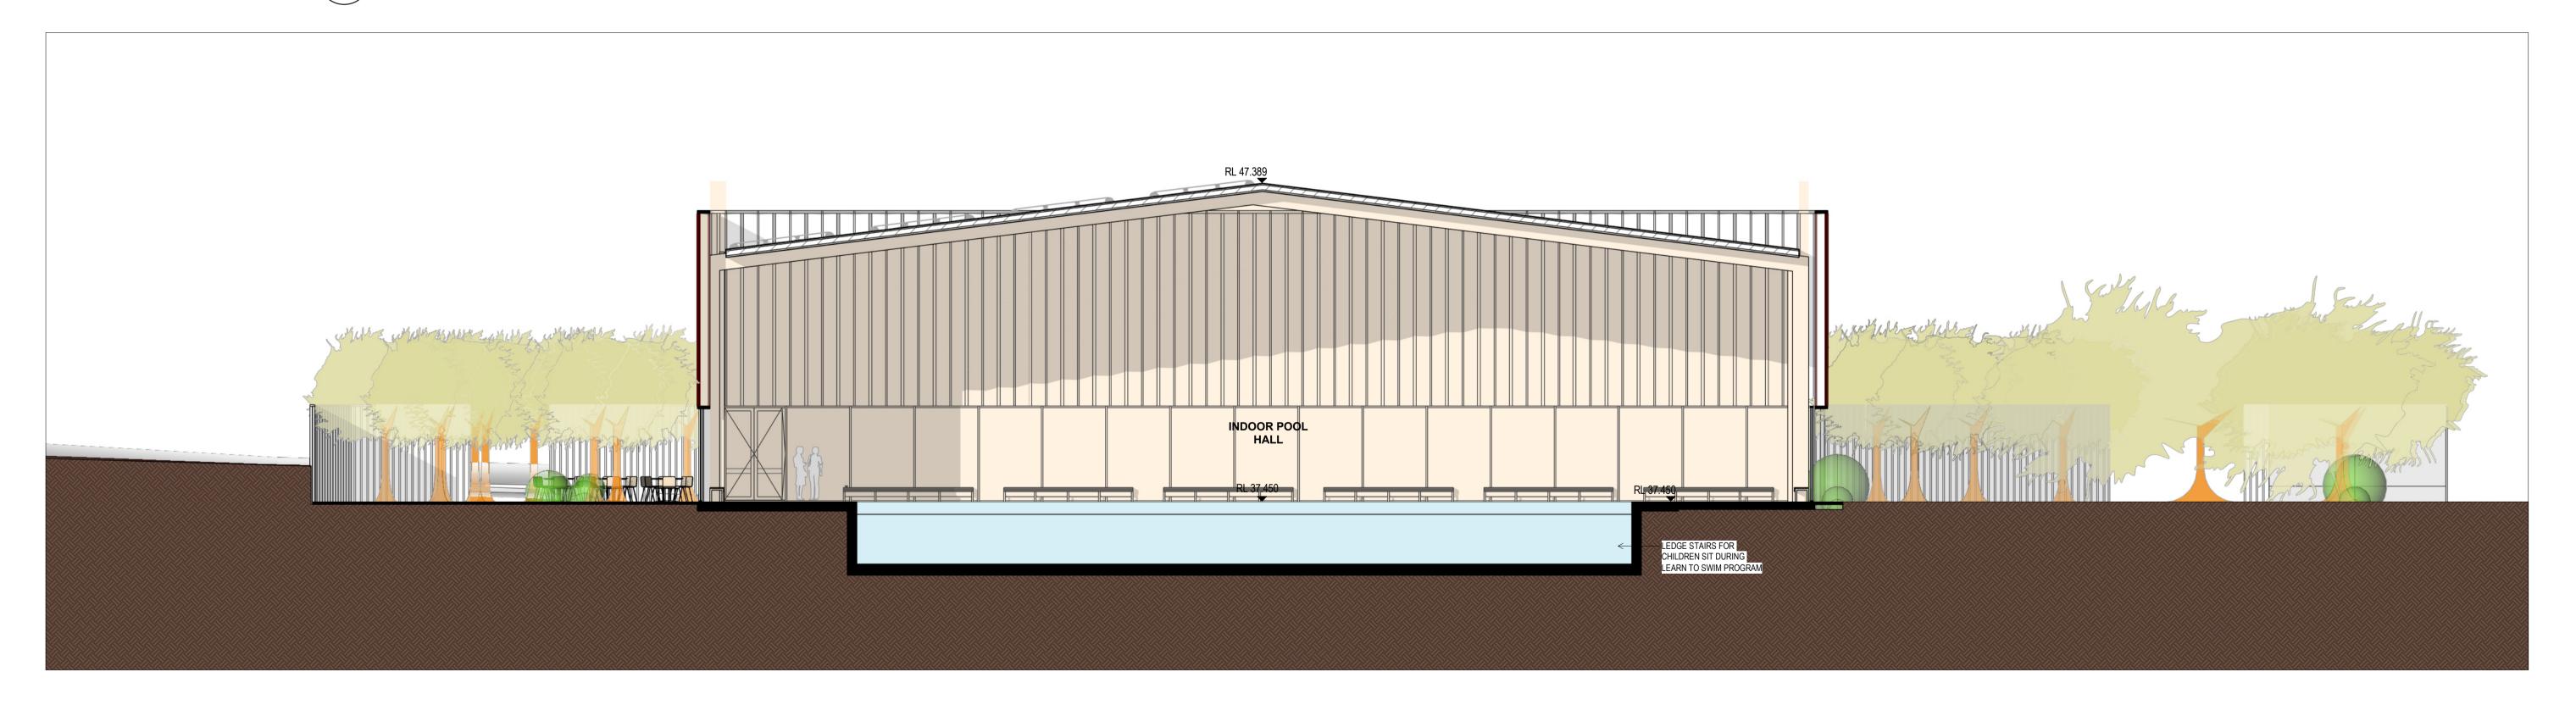

2 SECTION SHORT SECTION B-B
Scale: 1:100

REV	DESCRIPTION	AUTH	CHK	DATE
D	FROZEN ARCHITECTURE SET			21/06/2024
Е	FROZEN ARCHITECTURE SET			24/06/2024
F	FROZEN ARCHITECTURE SET			25/06/2024
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Н	DEVELOPMENT APPLICATION			03/07/2024

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STATUS DEVELOPMENT APPLICATION 0m 1 2 3 4 5

CUMBERLAND CITY COUNCIL







PROJECT GUILDFORD POOL MODERNISATION PROJECT LOT 21, DP 1018330, 1 TAMPLIN ROAD, GUILDFORD

SECTIONS AA & BB

CHECKED MW IZ ISSUE 03/07/2024 11:00:20 AM SCALE @ A1 1:100 PROJECT No STAGE DRAWING No REVISION 2 A MMX-AR-2100

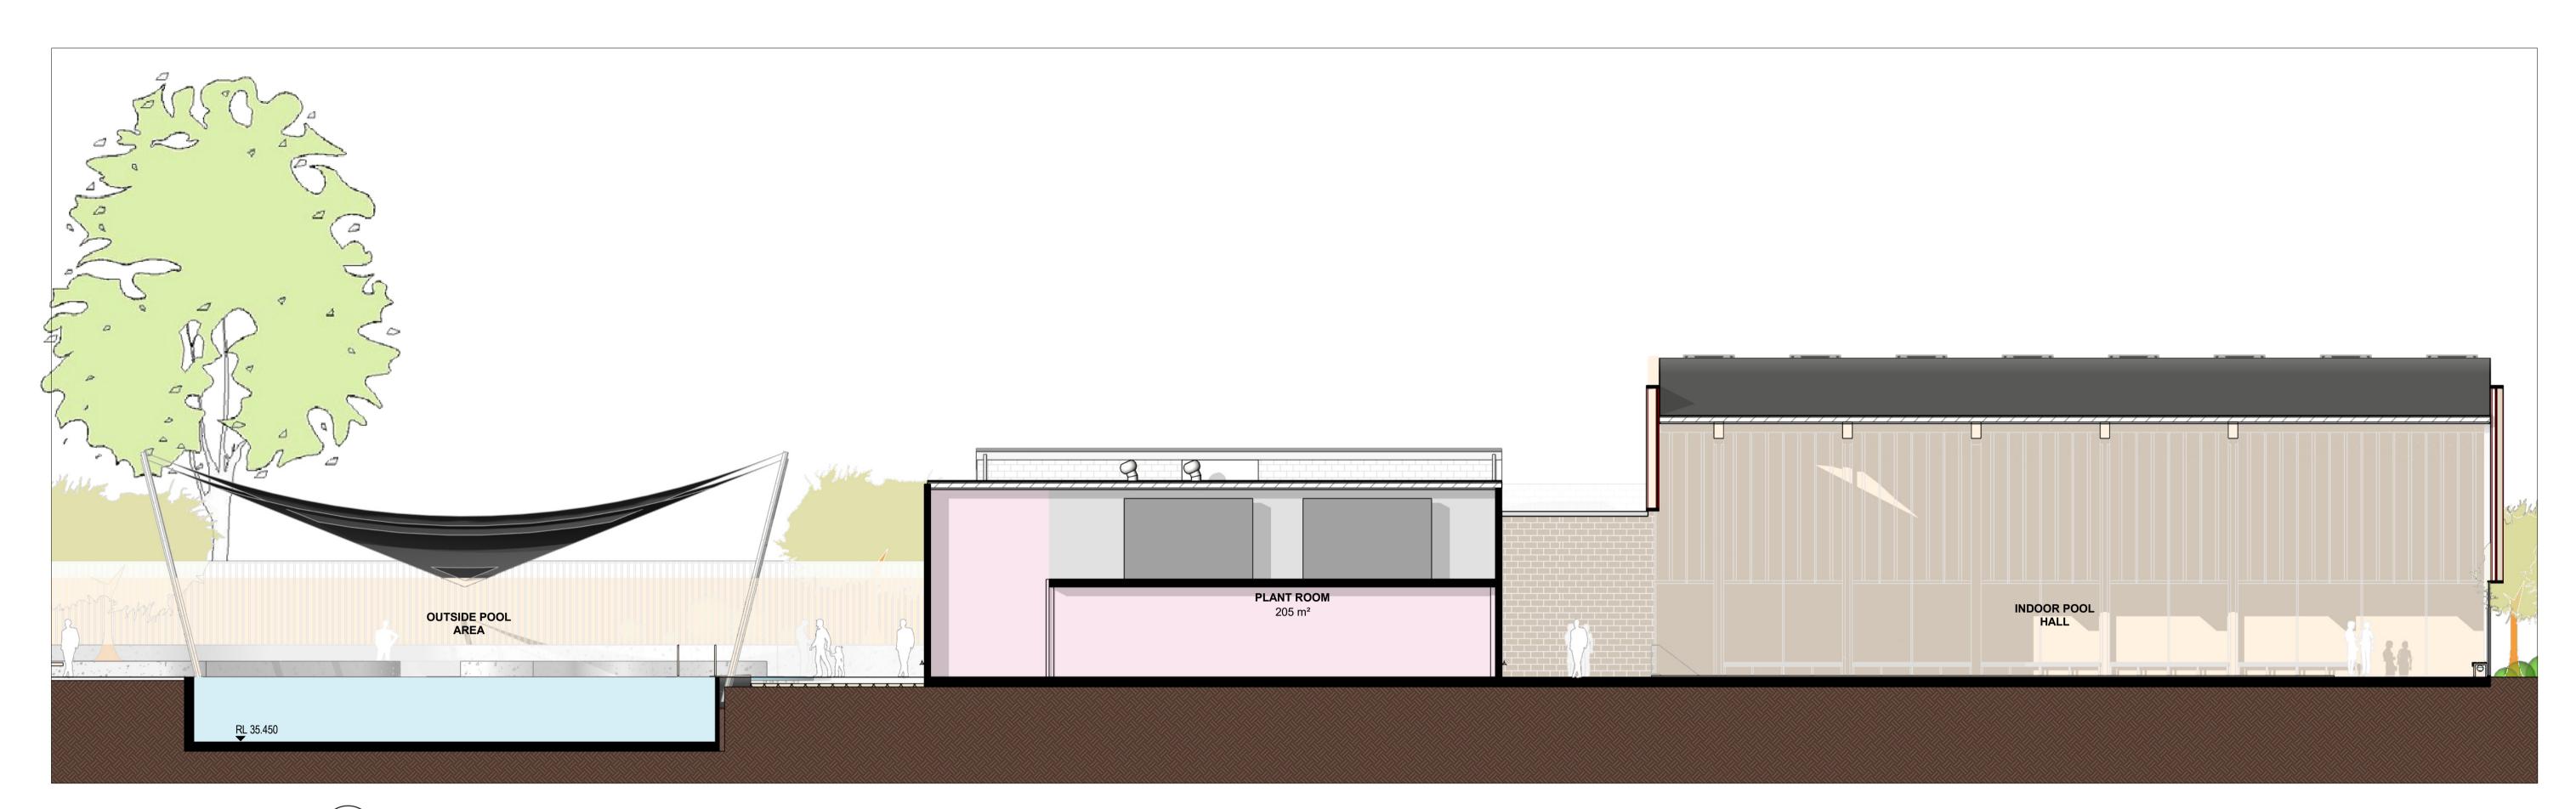



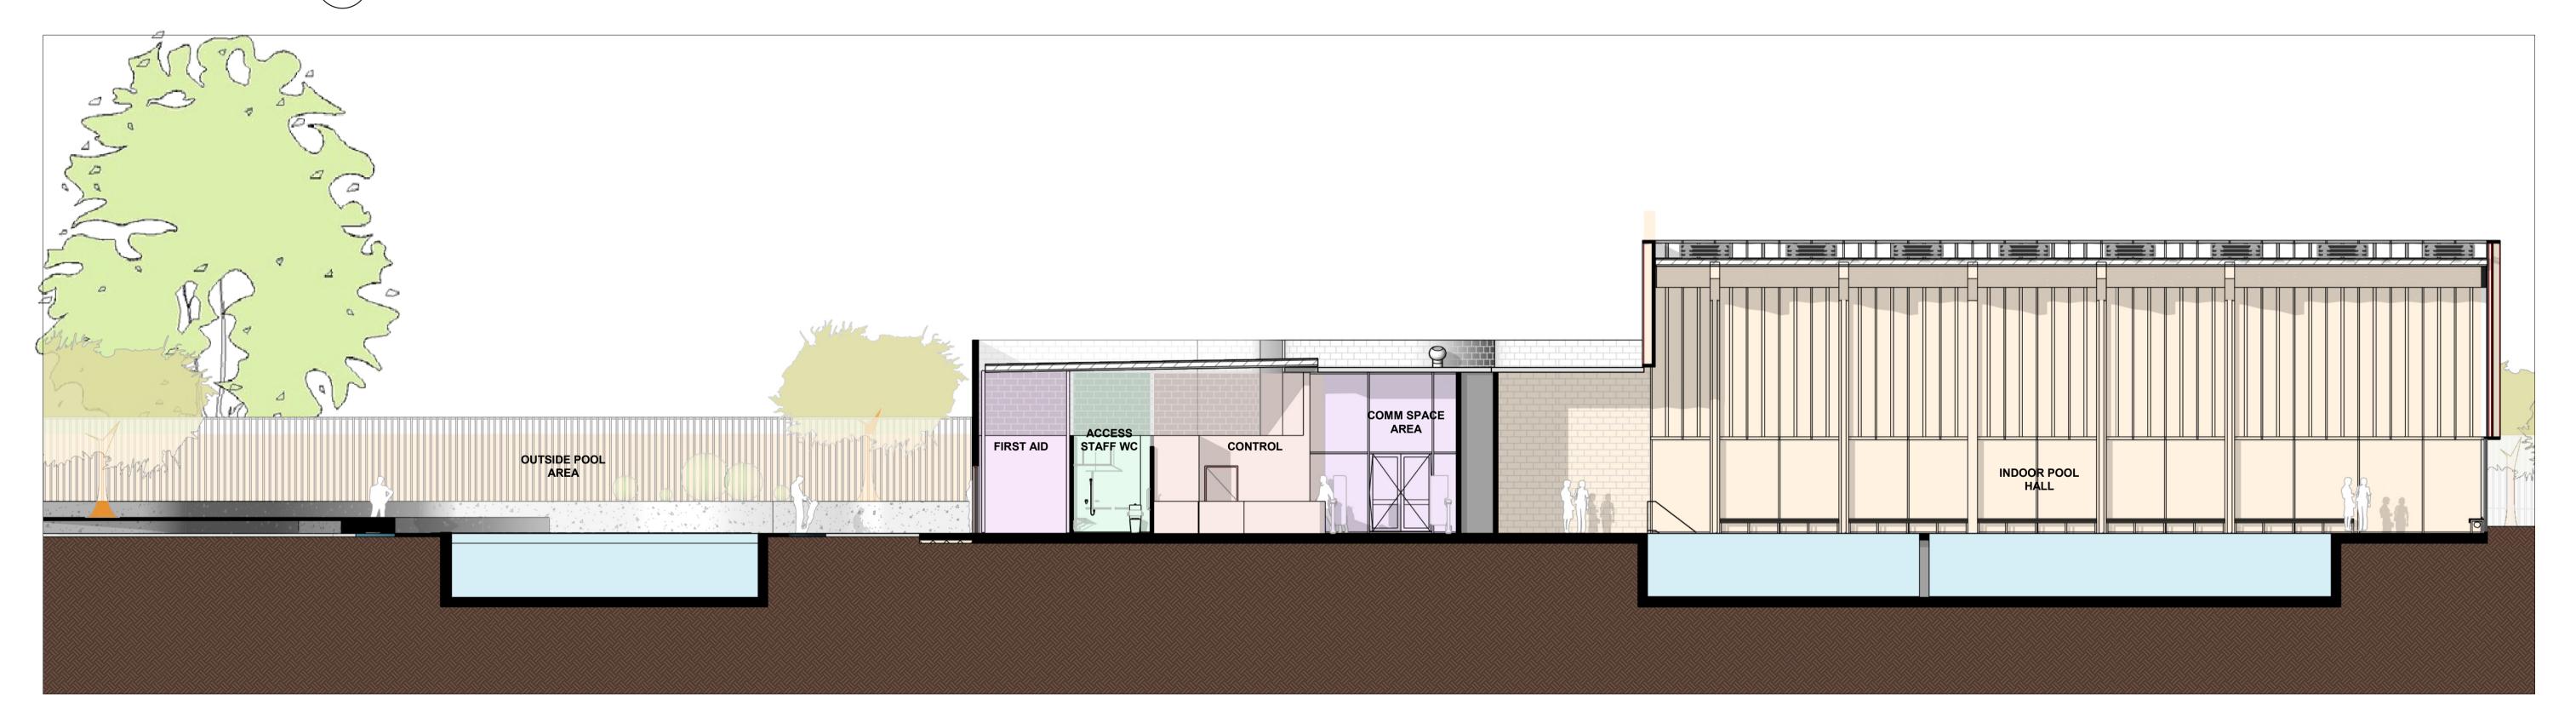

2 SECTION LONG SECTION D-D
1000 Scale: 1:100

REV	DESCRIPTION	AUTH	CHK	DATE
D	FROZEN ARCHITECTURE SET			21/06/2024
Е	FROZEN ARCHITECTURE SET			24/06/2024
F	FROZEN ARCHITECTURE SET			25/06/2024
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Н	DEVELOPMENT APPLICATION			03/07/2024

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APPLICATION
Om 1 2 3 4 5

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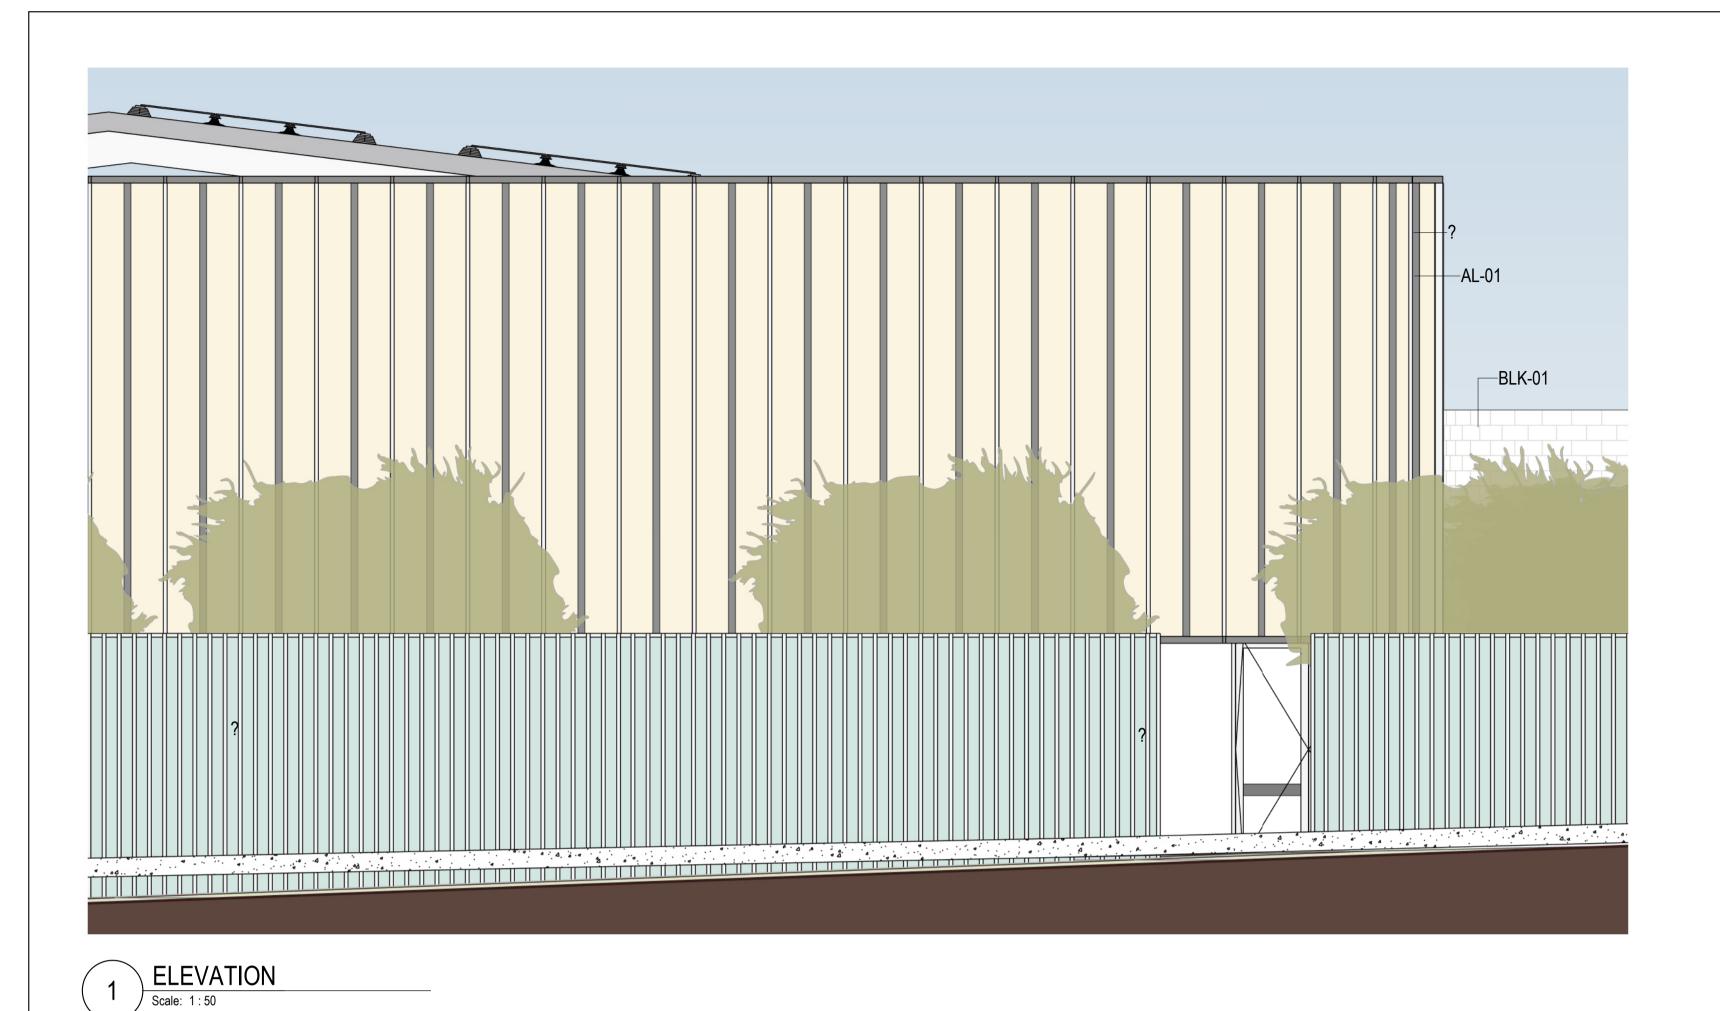





PROJECT
GUILDFORD POOL
MODERNISATION PROJECT
LOT 21, DP 1018330, 1 TAMPLIN ROAD, GUILDFORD

SECTIONS CC & DD

| DRAWN | CHECKED | MW | SCALE @ A1 | 1 : 100 | PROJECT No | STAGE | DRAWING No | REVISION | CHECKED | MW | SCALE @ A1 | 1 : 100 | PROJECT No | STAGE | DRAWING No | REVISION | CHECKED | MW | CREVISION | CREVISION | CHECKED | MW | CREVISION | CREV




MATERIAL LIST					
CODE	DETAIL	IMAGE			
AL-01	POWDERCOATED ALUMINIUM				
BLK-01	WHITE POLISHED MASONRY BLOCKWORK				
CON-01	EXPOSED CONCRETE				
FN-01	POWDERCOATED FENCE				
GLZ-01	CLEAR GLAZING FRAMED CURTAIN WALL SYSTEM				
MS-01	METAL SHEETING				
POL-01	POLYCARBONATE PANEL	11111			
SP-01	SOLID PANEL				
TL-01	AQUA BLUE TILES				

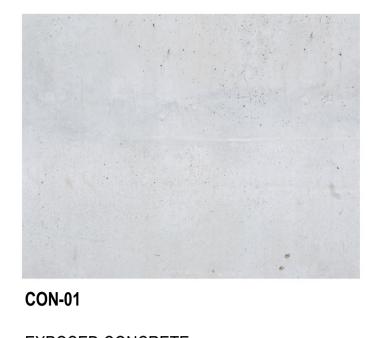



MS-01

EXPOSED CONCRETE

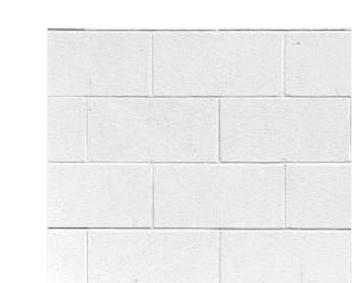

METAL SHEETING

POL-01

POLYCARBONATE FACADE PANELS WITH FIRE RATING SUBSTRATES.



WHITE POLISHED MASONRY BLOCKWORK



GLZ-01

CLEAR GLAZING FRAMED CURTAIN WALL SYSTEM



AL-01

POWDERCOATED ALUMINIUM



FN-01

POWDERCOATED FENCE



TIL-01

AQUA BLUE TILES




SP-01

SOLID PANEL



BLK - 01 FEATURE WALL

WHITE POLISHED MANSONRY BLOCKWORK - ROTATION

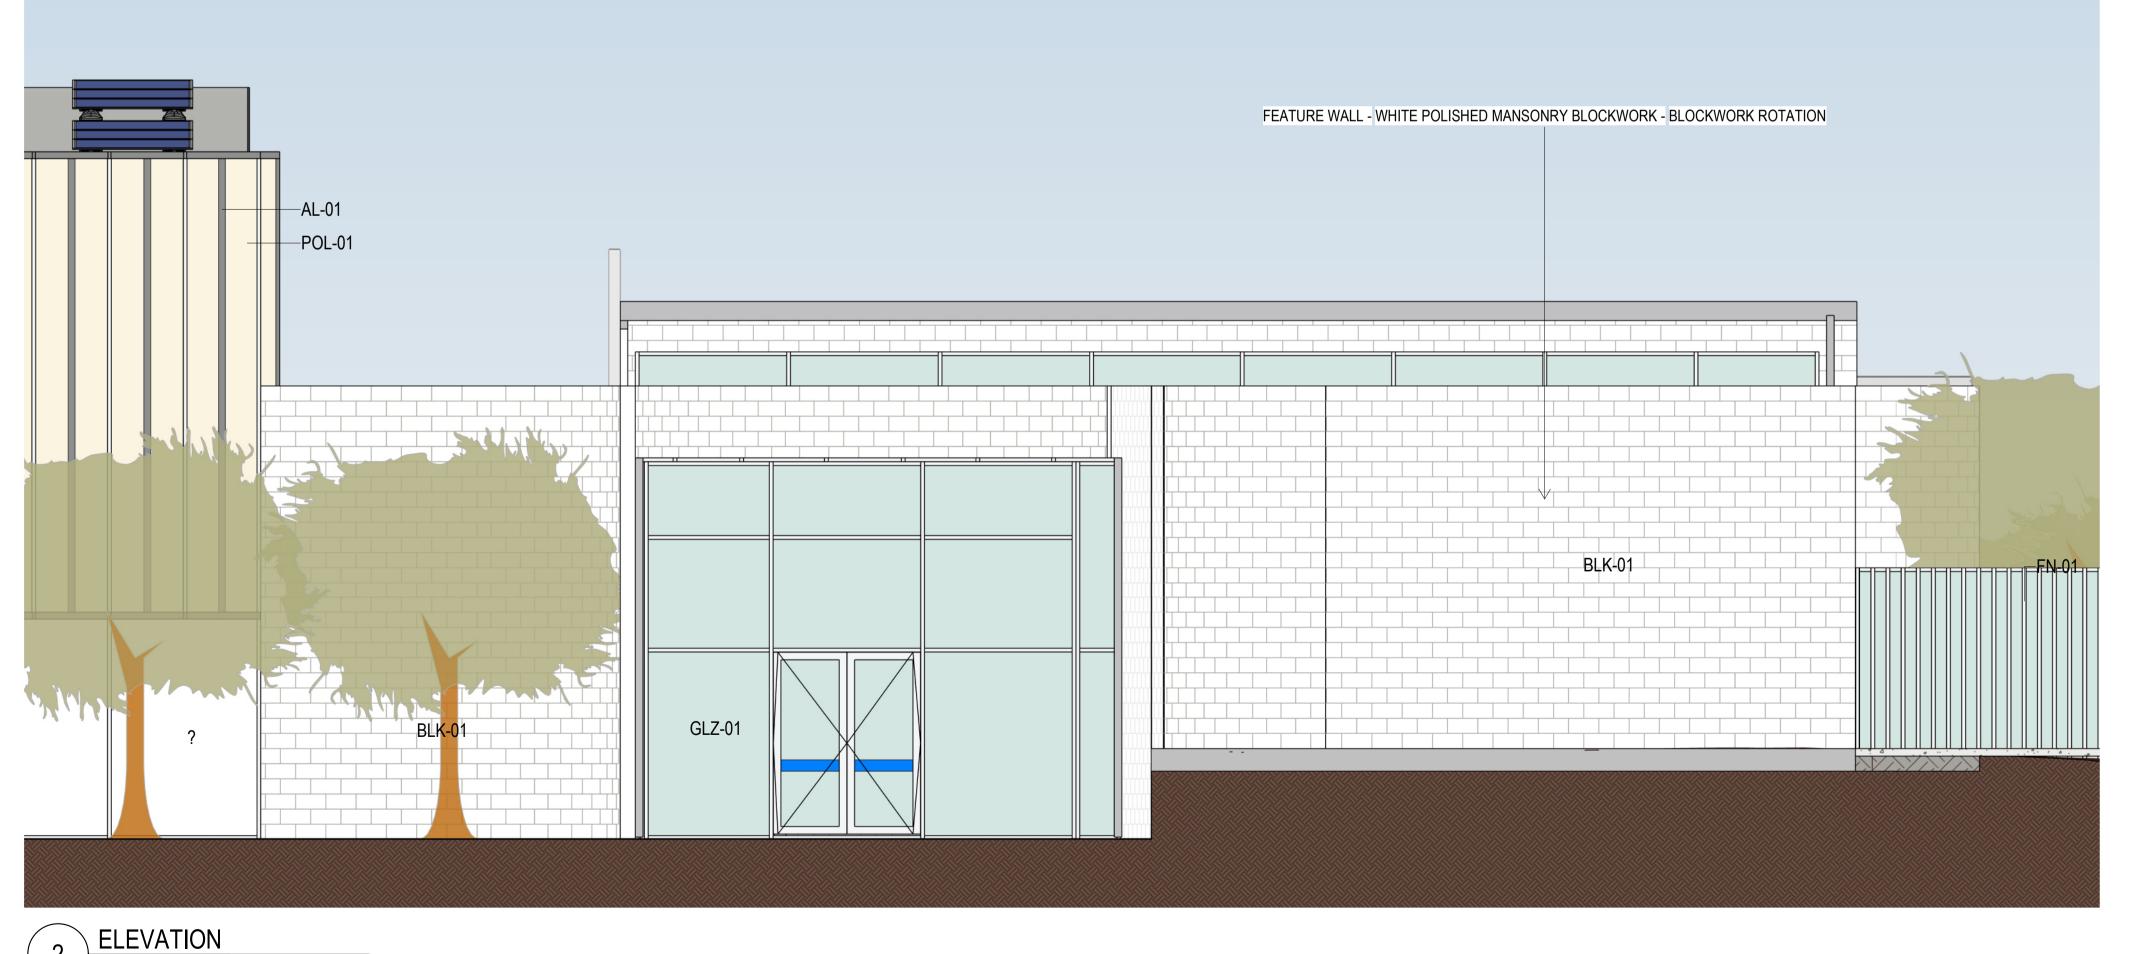



G FROZEN ARCHITECTURE SET

H FROZEN ARCHITECTURE SET

I DEVELOPMENT APPLICATION

AUTH CHK DATE

21/06/2024

24/06/2024

25/06/2024

26/06/2024

03/07/2024

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DEVELOPMENT
APLICATION

Om 1 2 3 4 5


CUMBERLAND CITY
COUNCIL





SYDNEY
Gadigal Country
Level 5, 111-117 Devonshire Street
Surry Hills, NSW 2010
T +61 2 8396 9500
syd@modedesign.com.au
ABN: 65 112 807 931

PROJECT
GUILDFORD POOL
MODERNISATION PROJECT
LOT 21, DP 1018330, 1 TAMPLIN ROAD, GUILDFORD

MATERIALS AND FINISHI

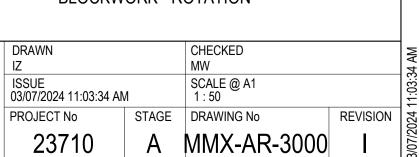

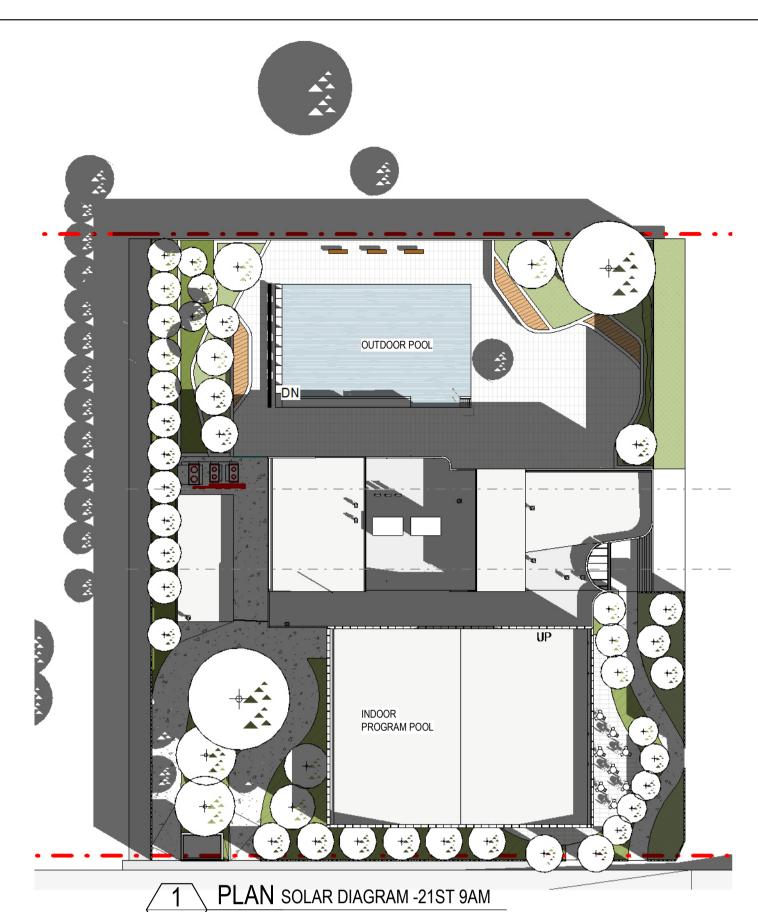

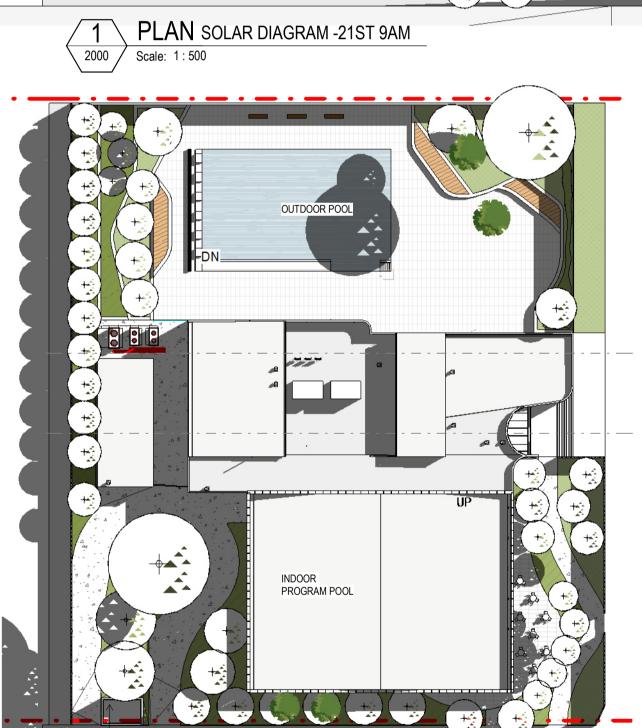















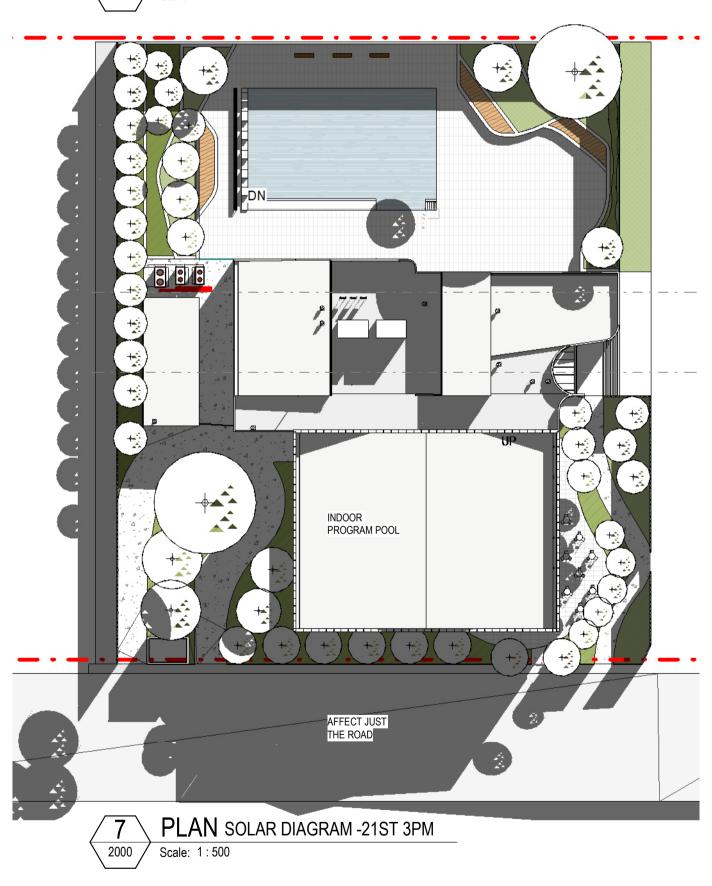

INDOOR PROGRAM POOL PLAN SOLAR DIAGRAM -21ST 12PM

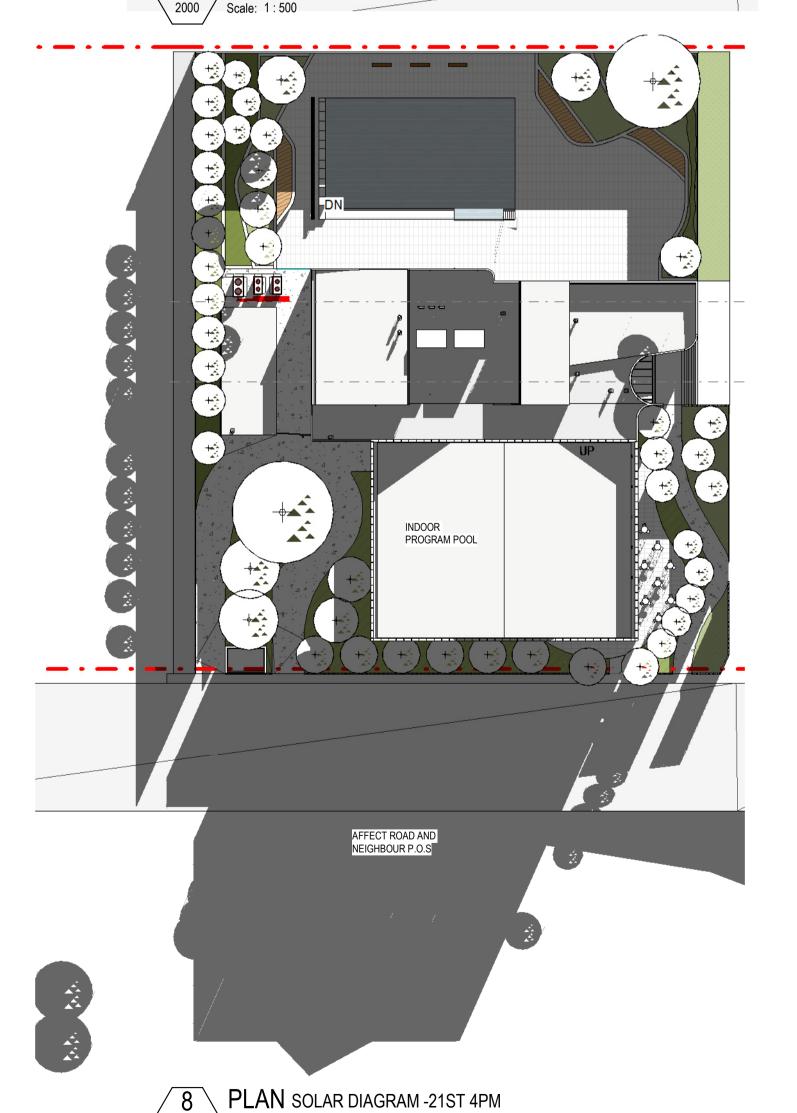

REV	DESCRIPTION	AUTH	CHK	DATE
С	FROZEN ARCHITECTURE SET			21/06/2024
D	FROZEN ARCHITECTURE SET			24/06/2024
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G	DEVELOPMENT APPLICATION			03/07/2024

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STATUS DEVELOPMENT APPLICATION 0m 1 2 3 4 5 NORTH

CUMBERLAND CITY COUNCIL







PROJECT GUILDFORD POOL **MODERNISATION PROJECT** LOT 21, DP 1018330, 1 TAMPLIN ROAD, GUILDFORD

DRAWING TITLE SHADOW DIAGRAMS - PLAN

2000 Scale: 1:500

ISSUE 03/07/2024 11:05:37 AM SCALE @ A1 SCALE @ A3 1:500 1:200 PROJECT No STAGE DRAWING No REVISION 2 A MMX-AR-4000 G

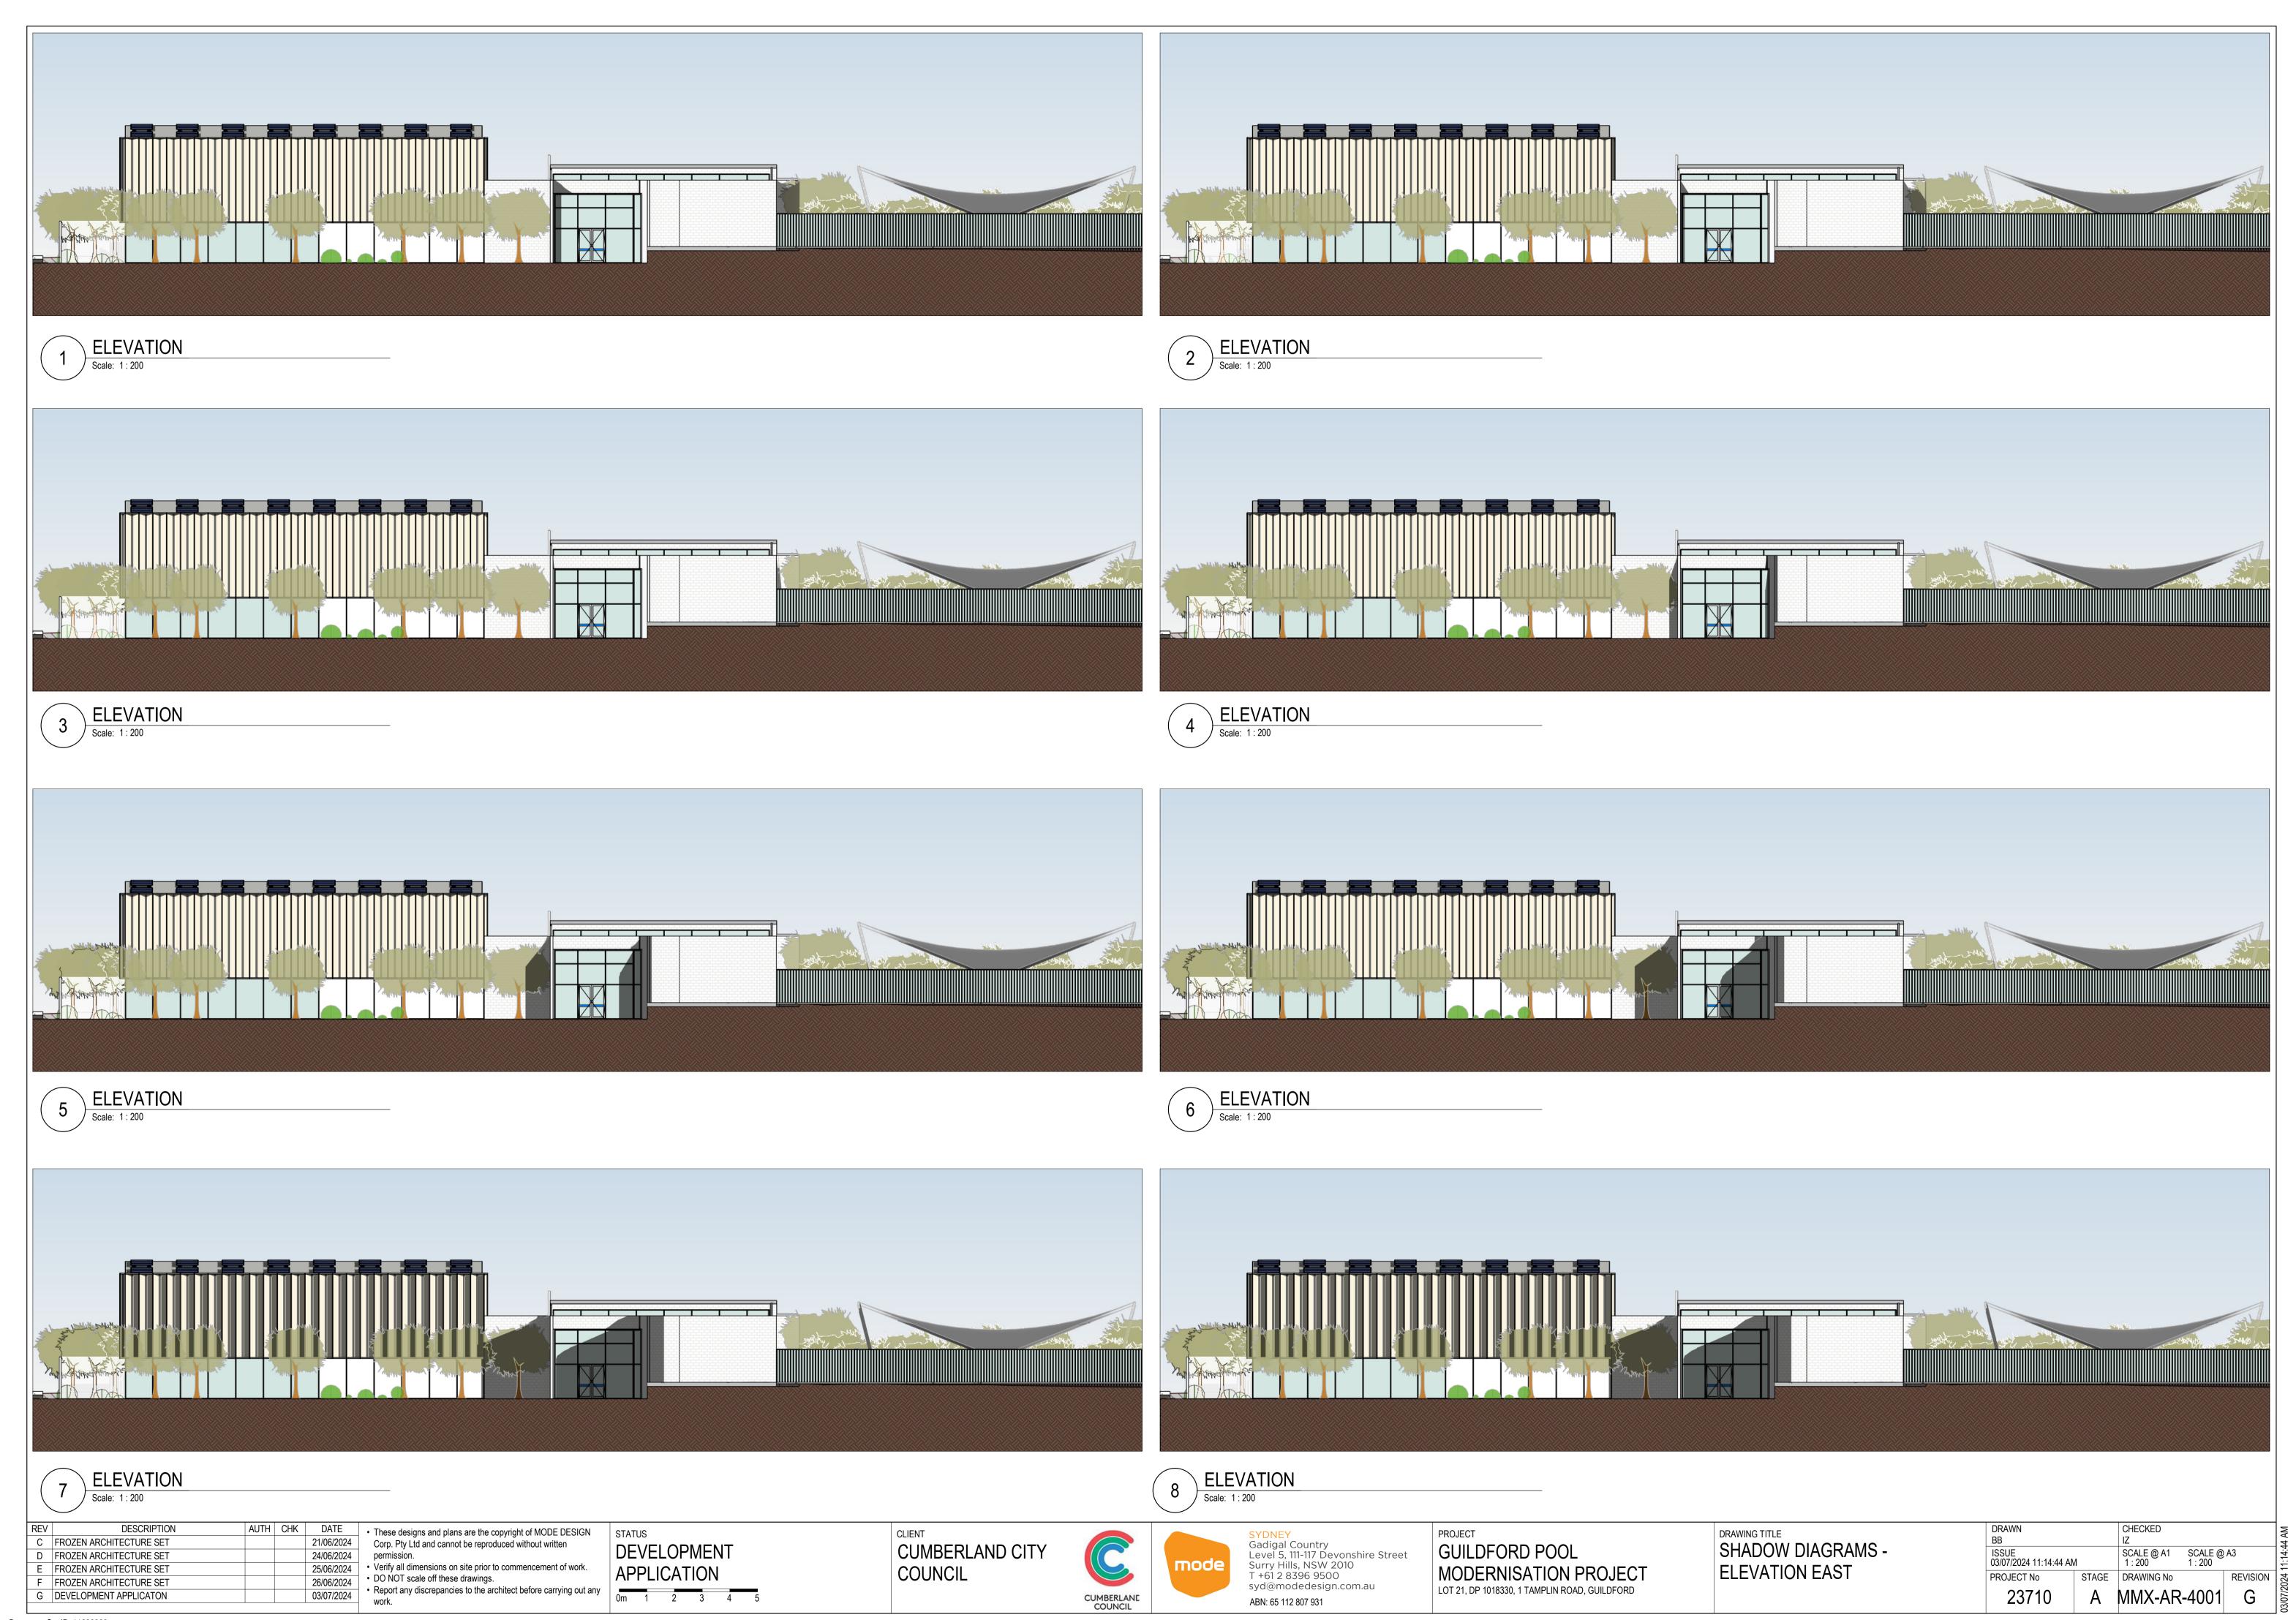

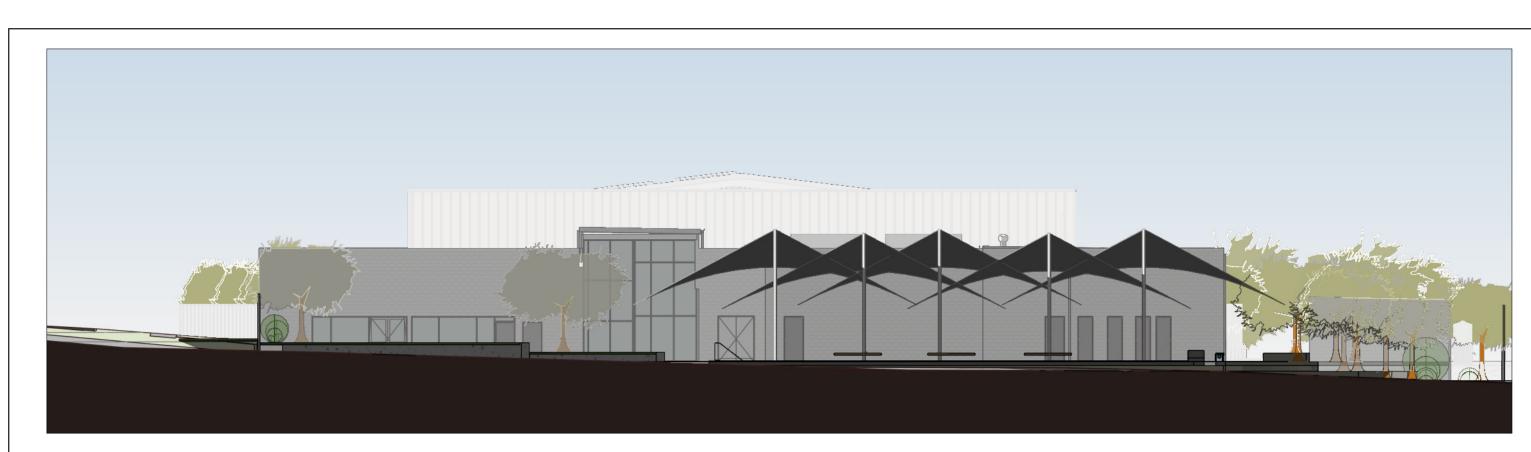






ELEVATION



ELEVATION Scale: 1:200

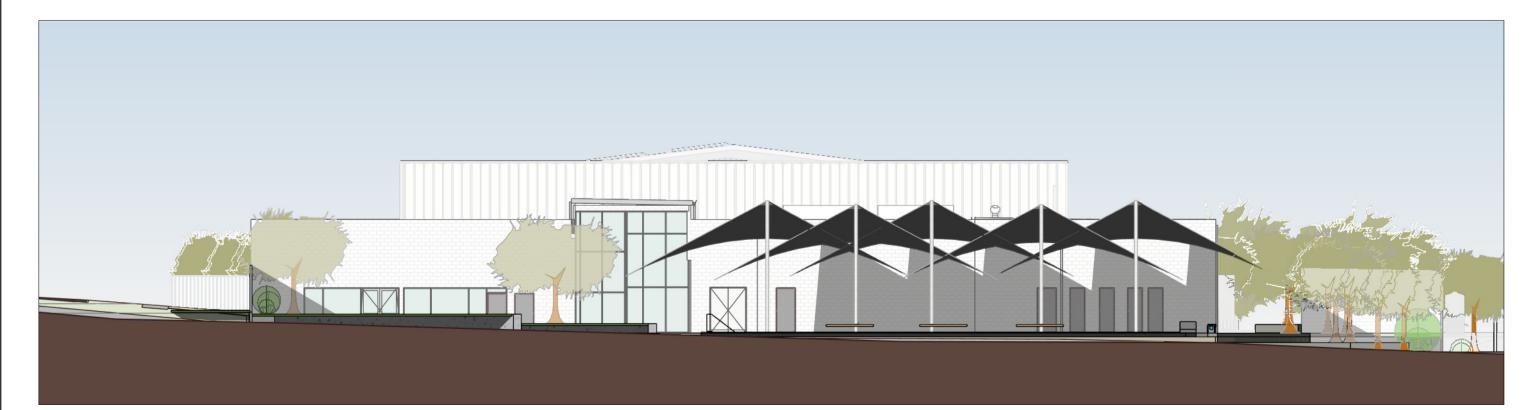

ELEVATION Scale: 1:200

DESCRIPTION These designs and plans are the copyright of MODE DESIGN Corp. Pty Ltd and cannot be reproduced without written B FROZEN ARCHITECTURE SET 19/06/2024 C FROZEN ARCHITECTURE SET 21/06/2024 Verify all dimensions on site prior to commencement of work.
DO NOT scale off these drawings. D FROZEN ARCHITECTURE SET 24/06/2024 E FROZEN ARCHITECTURE SET 25/06/2024 Report any discrepancies to the architect before carrying out any F FROZEN ARCHITECTURE SET 03/07/2024

STATUS DEVELOPMENT 0m 1 2 3 4 5 **CUMBERLAND CITY** COUNCIL






SYDNEY
Gadigal Country
Level 5, 111-117 Devonshire Street
Surry Hills, NSW 2010
T +61 2 8396 9500
syd@modedesign.com.au ABN: 65 112 807 931

PROJECT **GUILDFORD POOL** MODERNISATION PROJECT LOT 21, DP 1018330, 1 TAMPLIN ROAD, GUILDFORD

DRAWING TITLE
SHADOW DIAGRAMS -**ELEVATION NORTH**


CHECKED BB ISSUE 03/07/2024 11:23:15 AM SCALE @ A1 1:200 SCALE @ A3 1 : 200 PROJECT No REVISION 2

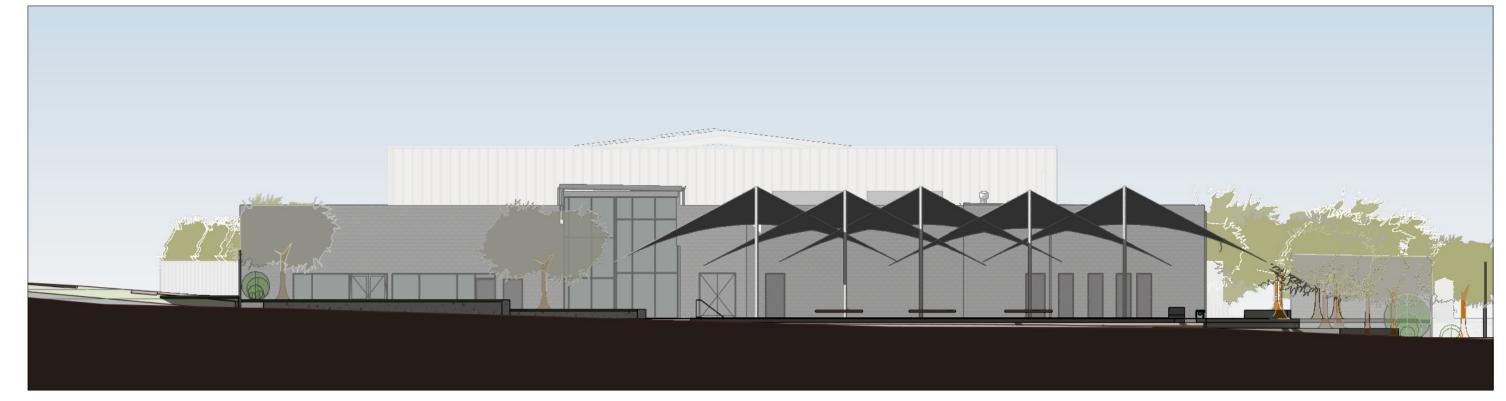

Scale: 1:200



Scale: 1:200

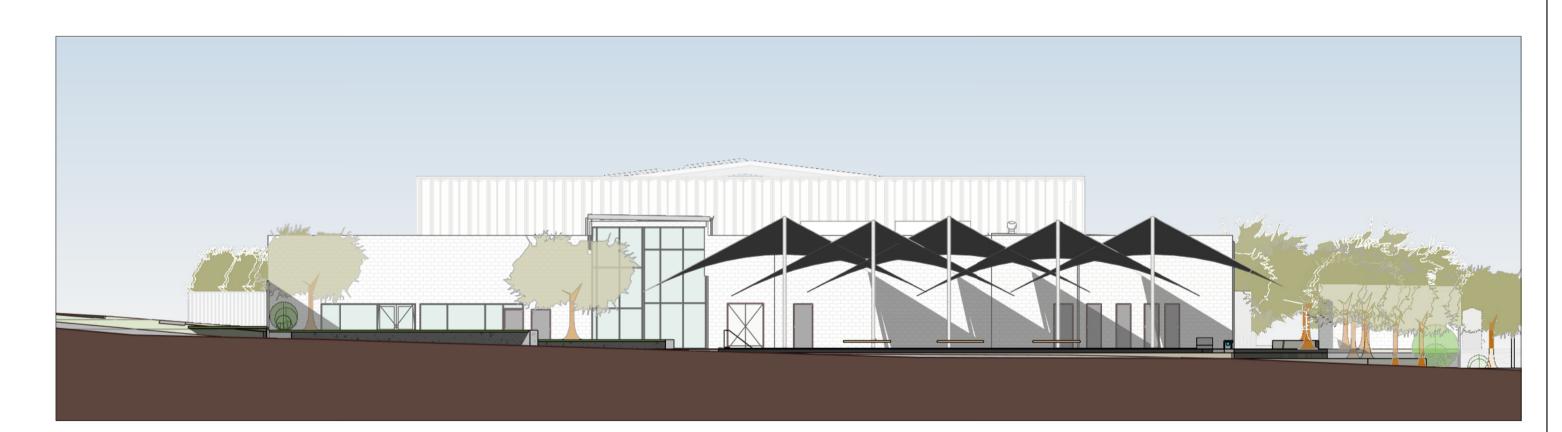

ELEVATION Scale: 1:200



NOT FOR CONSTRUCTION

Drawings are for design intent only.

All dimension, details and locations to be confirmed by sign maker and engineer prior to fabrication and installation.

Reference

Extracted from Cumberland Council Signage Manual 2018 (draft 17 April 2018). Use this document for further details and specifications.

ID07


SPECIFICATIONS

- 1. Freestanding 90x90mm SHS galvanised steel post with galvabond square steel metal post end caps painted 2 pack polyurethane to match: Resilient Black-Dulux Black PG1.A9, semi-gloss finish.
- 2. 3mm Aluminium removable panel painted both sides 2 pack polyurethane to match: Reliable Navy-Dulux Pacific Line P41.B9. Cumberland Brand Logo and white text to be computer cut vinyl applied direct to panel. Bottom strip painted 2 pack polyurethane: Taubmans = Magical Merlin T15 142.5; Dulux = Hot Lips S05.H9; Taubmans = Green Gloss T15 165.6. Sign typography, Cumberland Council QR code and website address to be computer cut Avery Supercast 900 white vinyl applied direct to panel. All item above to have a top anti-graffiti clear coat protective finish.
- 3. Mechanical fix to SHS post with countersunk (flat) stainless steel M10 socket head cap screws. Bolts to be centred with post and heads painted to match background.
- 4. Graphic Details: Cumberland Brand Logo: 100mmH Merrylands: Avenir Medium. 95mm Xheight Community Centre: Avenir Light. 95mm Xheight QRCode: 50mm
- 5. Concrete foundation and structure to be certified by a qualified engineer. All footings to be below ground. Engineer to provide specifications.

Panel to have anti-graffiti clear coat protective finish. Please refer to graphic layout for more information.

All measurements in millimeters unless noted. Provide shop drawings for review and approval by Cumberland Council.


NON ILLUMINATED

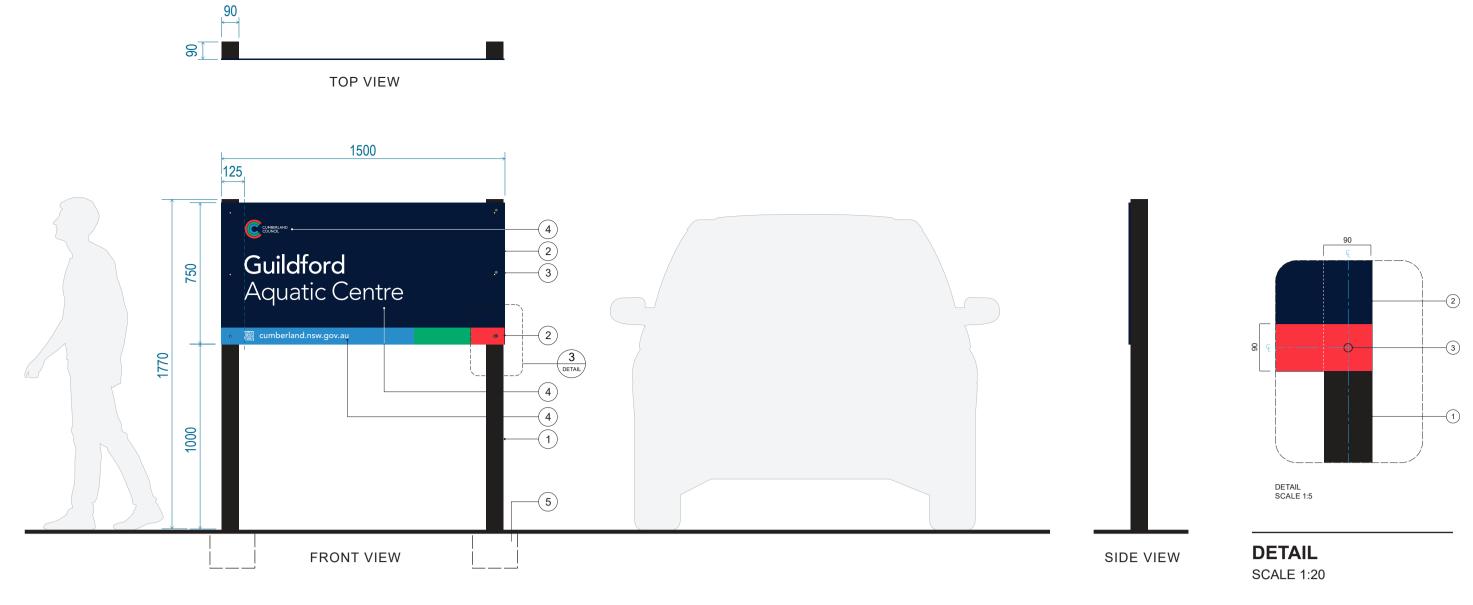

SIGN TYPE ID07 LOW GENERAL IDENTIFICATION

General Arrangement

SCALE 1:20

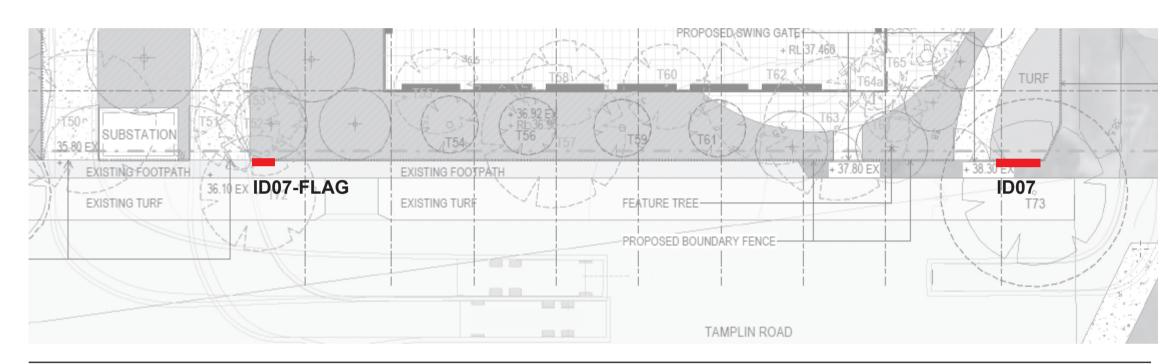

ID07 Location Guide

NOT TO SCALE

ID05a

SPECIFICATIONS


- 1. 4mm thick aluminium panel with #1 mill finish. All visible surfaces to have a top anti-graffiti clear coat protective finish.
- 2. Black text to be computer cut Avery Supercast 900 black vinyl applied direct to panel.
- 3. Cumberland Council Logo to be computer cut cast vinyl applied direct to panel. Vinyl on face to match: Taubmans = Magical Merlin T15 142.5; Dulux = Hot Lips S05.H9; Taubmans = Green Gloss T15 165.6.
- Bottom of sign to be mounted 1800mm above FFL. Fix sign flush to wall substrate using Fischer M10 Hex countersunk stainless steel high performance anchors FH II-SK and Ramset 'Pure Epoxy' chemical anchoring**. Use Sikaflex & clear VHB
- Guildford: Avenir Heavy. 115mm H Aquatic Centre: Avenir Light. 115mm H Cumberland Council Logo: 360mm H

adhesive tape to support panel.

6. ** Fixings and structure to be certified by a qualified engineer. Engineer to provide certification and specifications.

All measurements in millimeters unless noted. Provide shop drawings for review and approval by

NON ILLUMINATED

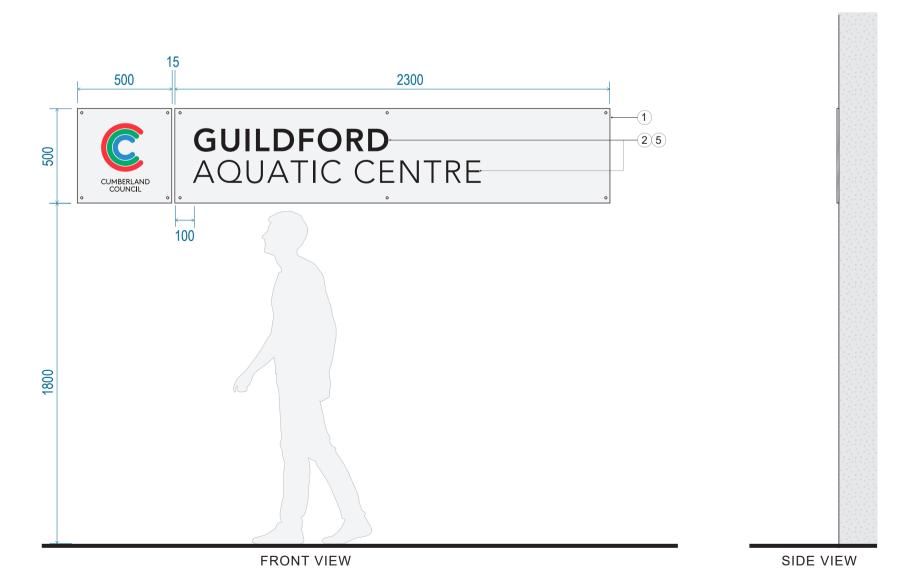


SIGN TYPE ID05.A STANDARD FACILITY IDENTIFICATION

Report any discrepancies to the architect before carrying out any

General Arrangement

SCALE 1:20

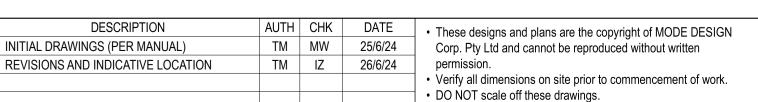

STATUS **DEVELOPMENT APPLICATION** 0m 2 4 6 8 10 NORTH

CUMBERLAND CITY COUNCIL







PROJECT **GUILDFORD POOL MODERNISATION PROJECT** LOT 21, DP 1018330, 1 TAMPLIN ROAD, GUILDFORD

DRAWING TITLE **EXTERNAL IDENTIFICATION** SIGNAGE OVERVIEW

SCALE @ A1 SCALE @ A3 ISSUE 26/6/24 1:200 1:400 PROJECT No STAGE DRAWING No REVISION 23710 GD-7001 B DA

SIDE VIEW

SIGN ID07-FLAG **LOW GENERAL IDENTIFICATION - FLAGGED POST VARIANT**


General Arrangement

SCALE 1:20

NOTE: Custom sign design not in manual. Based on ID07 format with IN01 elements.


FRONT VIEW

TOP VIEW

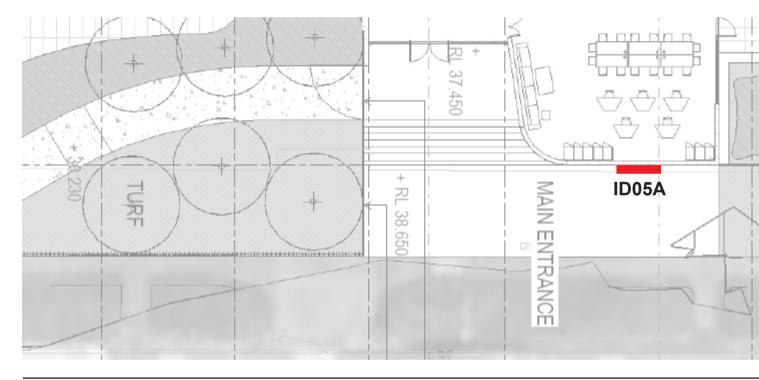

ID05A Location Guide

NOT TO SCALE

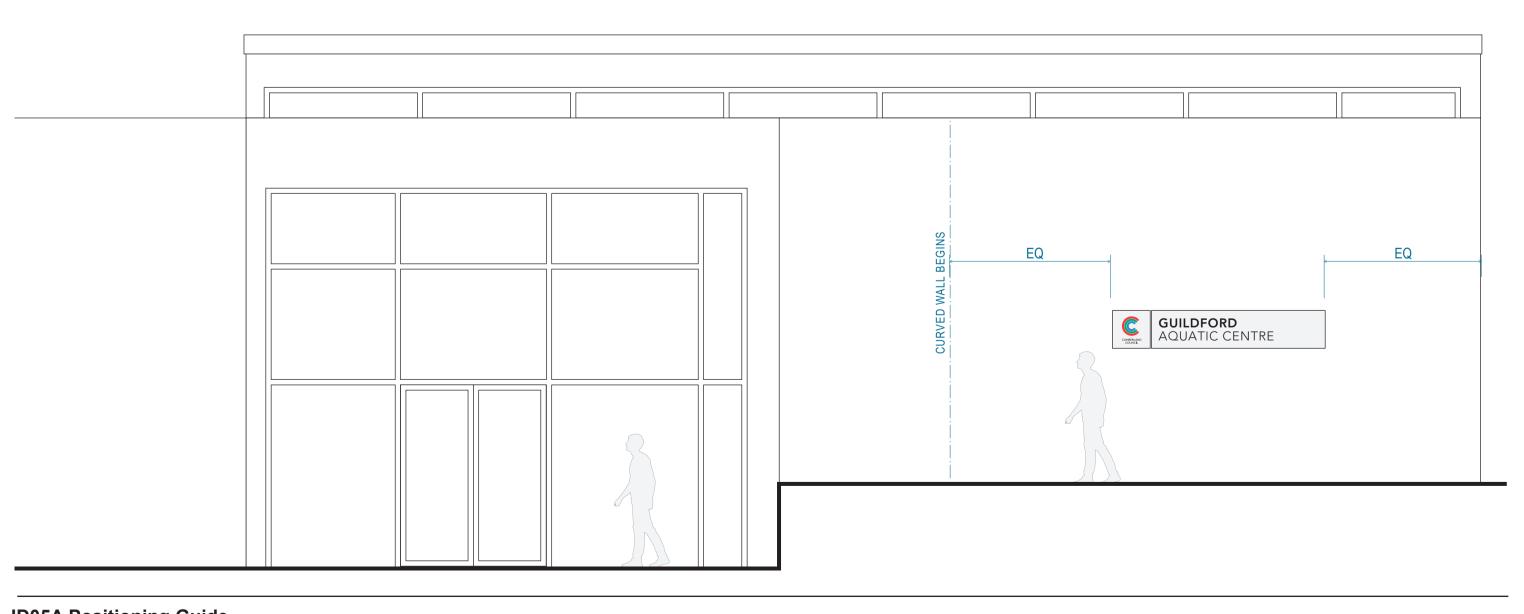

ID05A Positioning Guide SCALE 1:50

INITIAL DRAWINGS (PER MANUAL)

DESCRIPTION

GUILDFORD POOL MODERNISATION PROJECT

This project is located on Darug Country

CUMBERLAND CITY COUNCIL LOT 21, DP 1018330, 1 TAMPLIN ROAD, GUILDFORD



DRAWING LIST				
NO.	SHEET NAME	REVISION		
LD -0001	COVER SHEET	5		
LD- 1001	LANDSCAPE PLAN	6		
LD- 1300	PLANTING SCHEDULES	4		
LD- 1301	PLANTING PLAN	5		
LD- 5001	SOFTWORKS DETAILS 1	3		
LD- 5002	SOFTWORKS DETAILS 2	3		



SYDNEY

Gadigal Country

Level 5, 111-117 Devonshire St


Surry Hills NSW 2010

T +61 2 8396 9500 syd@modedesign.com.au 011 1 2 3 4 3

STATUS: REVISED DEVELOPMENT

APPLICATION 11.09.2024

PROJECT No: 23710

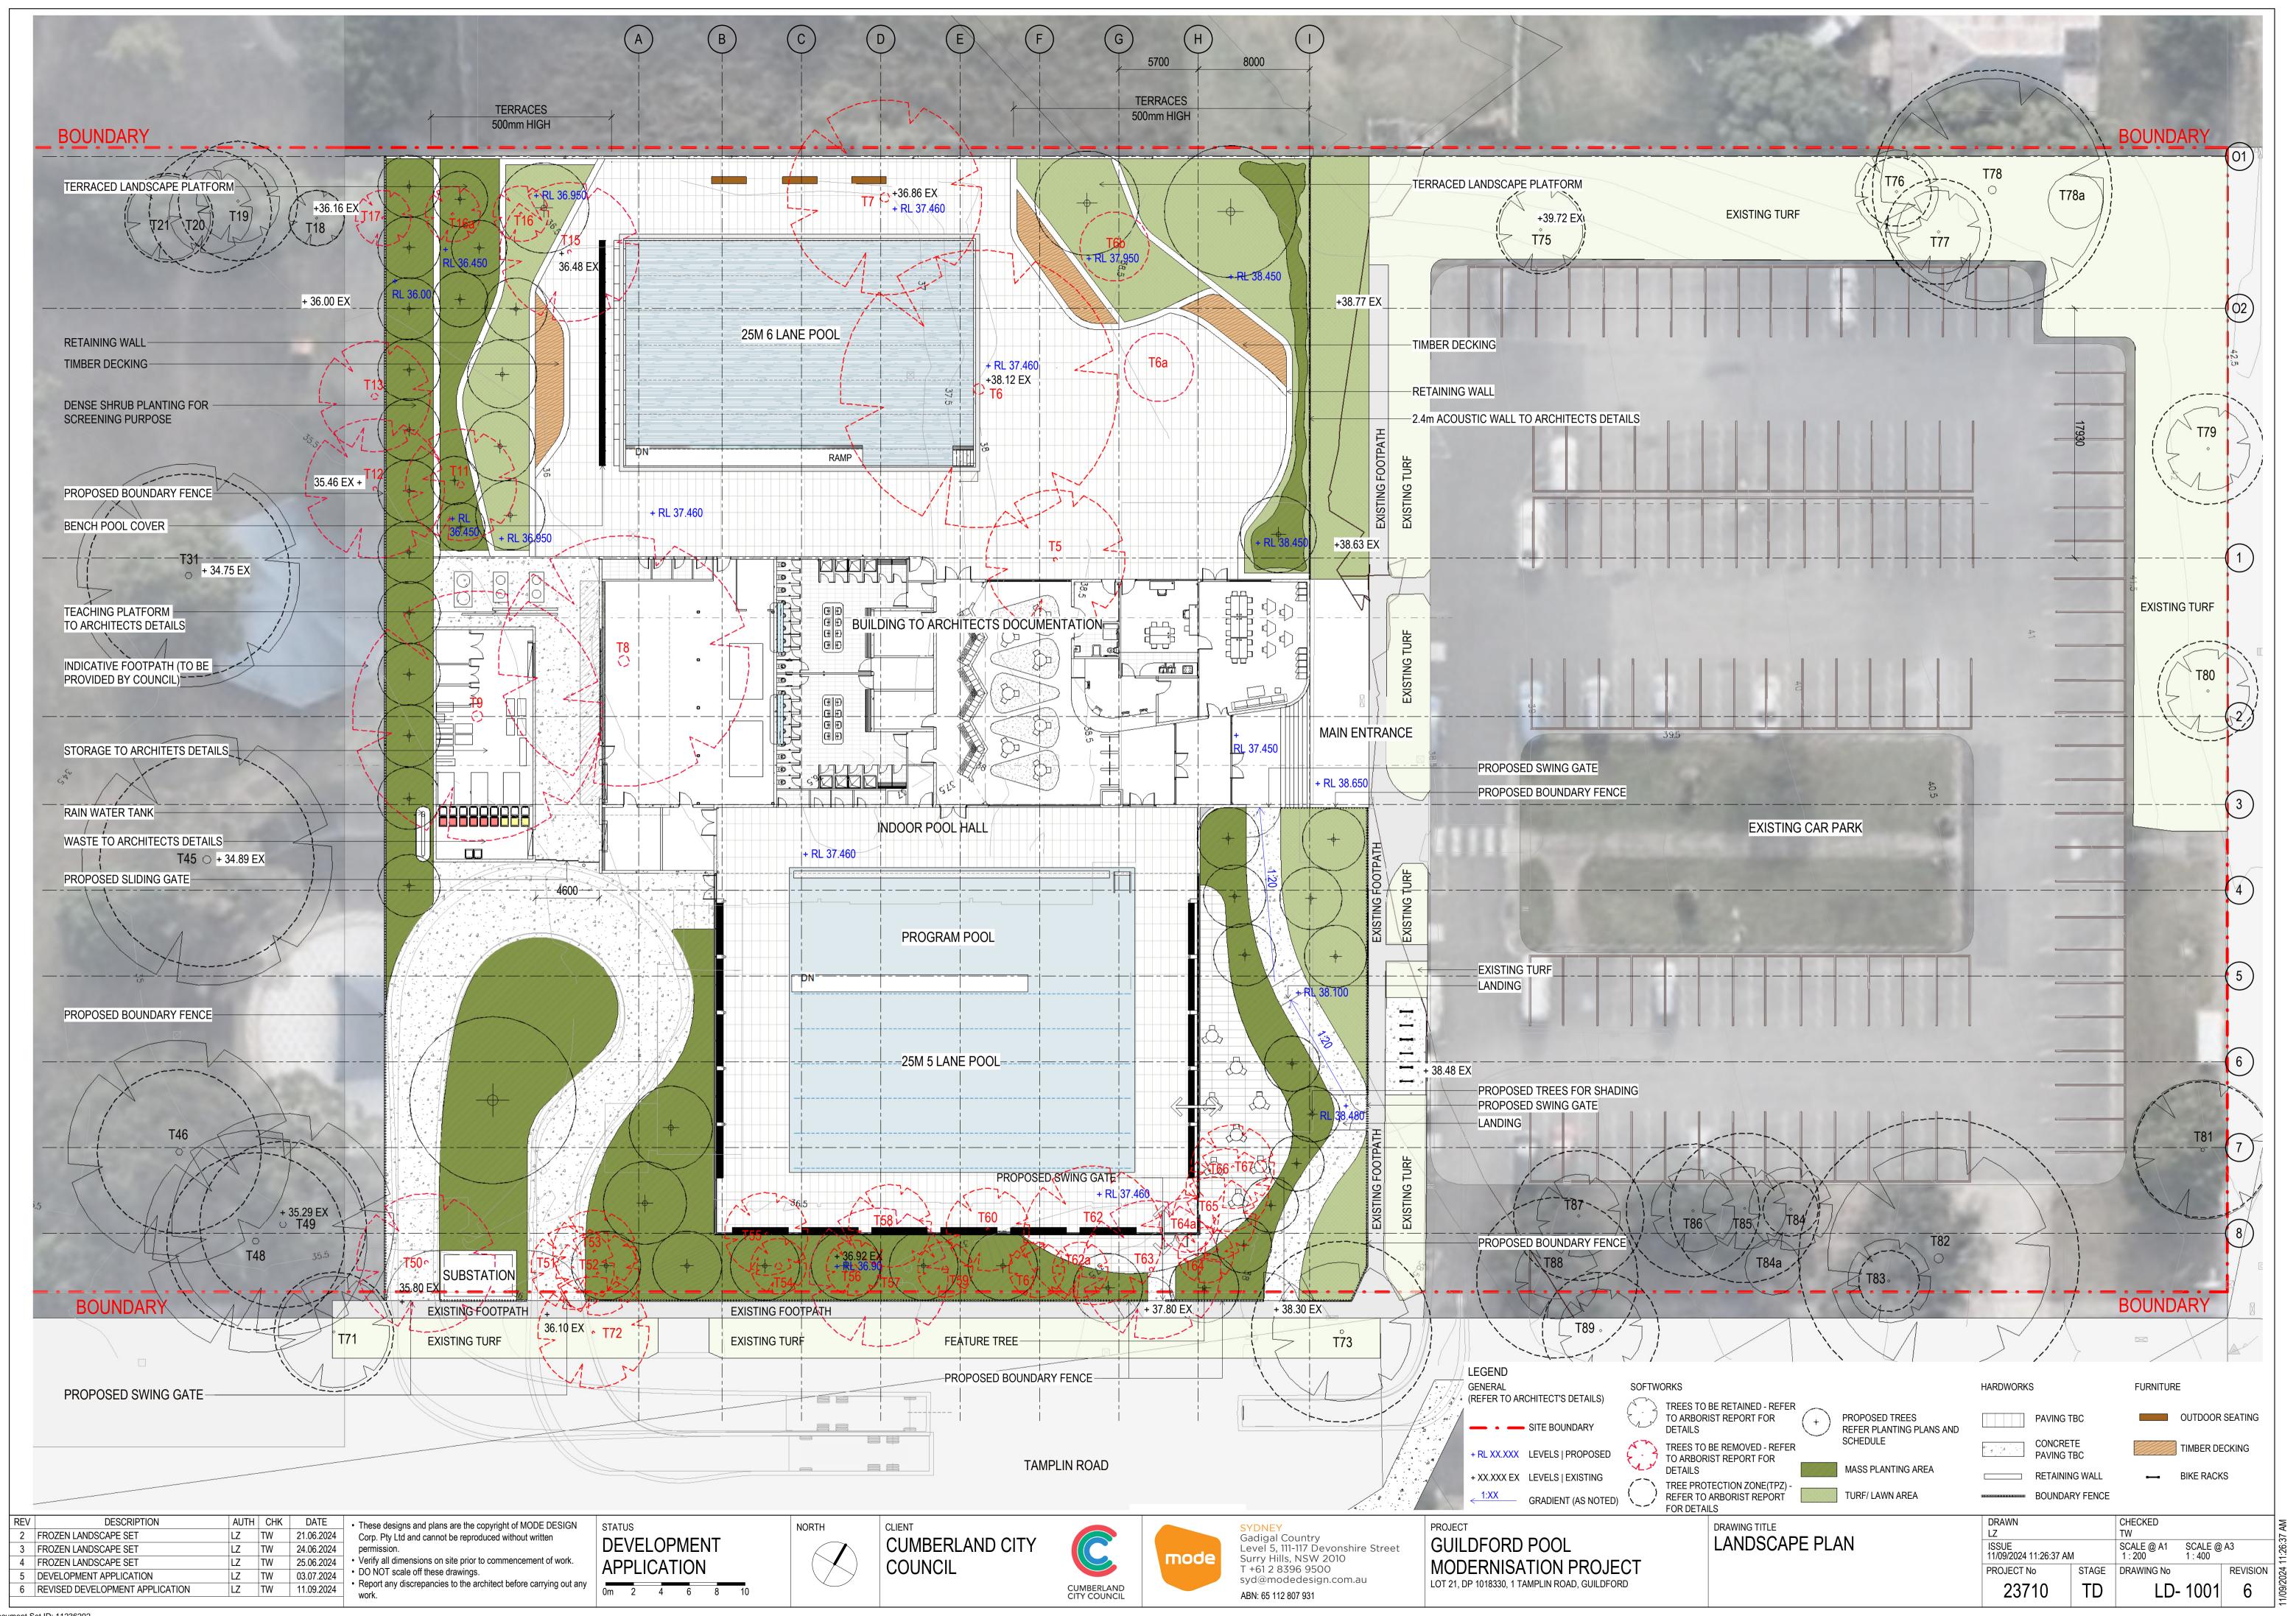

		PLAN	TING SCHED	DULE			
	PLA	ANT			DIMENSIO	NS	
CODE	BOTANIC NAME	COMMON NAME	ORIGIN	POT SIZE (MIN.)	HEIGHT (min)	SPREAD (min)	QUANTITY
TREES	(<u>NOTE</u> : STAKE TREES AS REQUIRED. REFER TO	D DETAIL 3 & 4 LD - 5002.)					
BACcit	BACKHOUSIA citriodora	Lemon Scented Myrtle	Native	100Ltr	8000	5000	
BANint	BANKSIA integrifolia	Honeysuckle Banksia	Native	200Ltr	8000	6000	1
ELAret	ELAEOCARPUS reticulatus	Blueberry Ash	Native	100Ltr	8000	4000	•
EUCmol	EUCALYPTUS moluccana	Gum-topped box	Native	400Ltr	20000	12000	
LAGind	LAGERSTROEMIA INDICA	Crape myrtle	Exotic	200Ltr	8000	8000	
TRllau	TRISTANIOPSIS laurina	Water Gum	Native	100Ltr	6000	4000	
WAHrob	WASHINGTONIA robusta	Mexican Fan Palm	Exotic	200Ltr	15000	2500	
SHRUBS							
ACAcul	ACACIA cultriformis 'Cascade'	Cascade Knife-leaf Wattle	Native	140mm	500	2000	
CORalb	CORREA alba	White correa	Native	200mm	1000	1500	
CRAblu	CRASSULA bluebird	Bluebird Jade	Exotic	200mm	1000	1000	
HELpet	HELICHRYSUM petiolare 'Licorice'	Silver-bush everlastingflower	Exotic	140mm	500	1000	
INDaus	INDIGOFERA australis	Australian Indigo	Native	140mm	2000	2000	
LEPlae	LEPTOSPERMUM laevigatum 'Shore Tuff'	Coastal Tea Tree	Native	140mm	500	1200	
MELthy	MELALEUCA thymifolia	Honey-myrtle	Native	200mm	1000	1000	
PULmic	PULTENAEA microphylla	Fine-leaved Bush Pea	Native	140mm	1500	1500	
WESblu	WESTRINGIA fruticosa 'Blue Gem'	Native Rosemary	Native	200mm	1200	1200	
	WESTRINGIA fruticosa 'Grey Box'	Coastal Rosemary	Native	140mm	500	500	
WESmun	WESTRINGIA fruticosa ' Mundi'	Coastal Rosemary	Native	140mm	500	1500	
WESsmo	WESTRINGIA fruticosa 'Smokey'	Coastal Rosemary	Native	200mm	1200	1200	
GROUND	OCOVERS						
ARTcir	ARTHROPODIUM cirratum	New Zealand Rock Lily	Exotic	140mm	800	800	2
CARgla	CARPOBROTUS glaucescens	Pig face	Native	140mm	300	2000	2
CHRapi	CHRYSOCEPHALUM apiculatum	Yellow Bottons	Native	140mm	300	1500	
HIBsca	HIBBERTIA scandens	Guinea Flower	Native	140mm	1000	2500	
SENser	SENECIO serpens 'Blue Chalksticks'	Blue Chalksticks	Exotic	140mm	500	800	
VIOhed	VIOLA hederacea	Native Violet	Native	140mm	200	1000	3
GRASSE	S						
DIAcae	DIANELLA caerulea 'Little Jess'	Little Jess	Native	140mm	400	400	2
DIArev	DIANELLA revoluta	Blue Flax Lilly	Native	140mm	400	400	2
LIRjus	LIRIOPE muscari 'Just Right'	Just Right	Exotic	140mm	500	500	
LOMhys	LOMANDRA hystrix	Mat-rush	Native	140mm	1000	1000	4
LOMnya	LOMANDRA longifolia 'Nyalla'	Nyalla	Native	140mm	800	800	
POAlab	POA labillardieri	Tussock Grass	Native	140mm	1000	600	2
THEtri	THEMEDA triandra	Kangaroo Grass	Native	140mm	1200	500	1
			1			1 1 1 1 1 1 1 1 1 1 1 1 1 1 1 1 1 1 1 1	<u>'</u>
TURF GF		Buffalo Grass	Native	Rolls	300	N/A	REFER PLAN(n
IUNE	SIR Walter 'Buffalo'	Dullalo Grass	INAUVE	1/0119	300	N//_	INLI LIN FLAIN(II

REV	DESCRIPTION	AUTH	CHK	DATE
1	FROZEN LANDSCAPE SET	LZ	TW	21.06.202
2	FROZEN LANDSCAPE SET	LZ	TW	24.06.202
3	DEVELOPMENT APPLICATION	LZ	TW	03.07.202
4	REVISED DEVELOPMENT APPLICATION	LZ	TW	11.09.202

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DEVELOPMENT APPLICATION

CUMBERLAND CITY COUNCIL






PROJECT
GUILDFORD POOL
MODERNISATION PROJECT
LOT 21, DP 1018330, 1 TAMPLIN ROAD, GUILDFORD

PLANTING SCHEDULES

| DRAWN | CHECKED | TW | SCALE @ A1 | SCALE @ A3 | NTS | NTS | NTS | SCALE @ A3 | NTS | NT



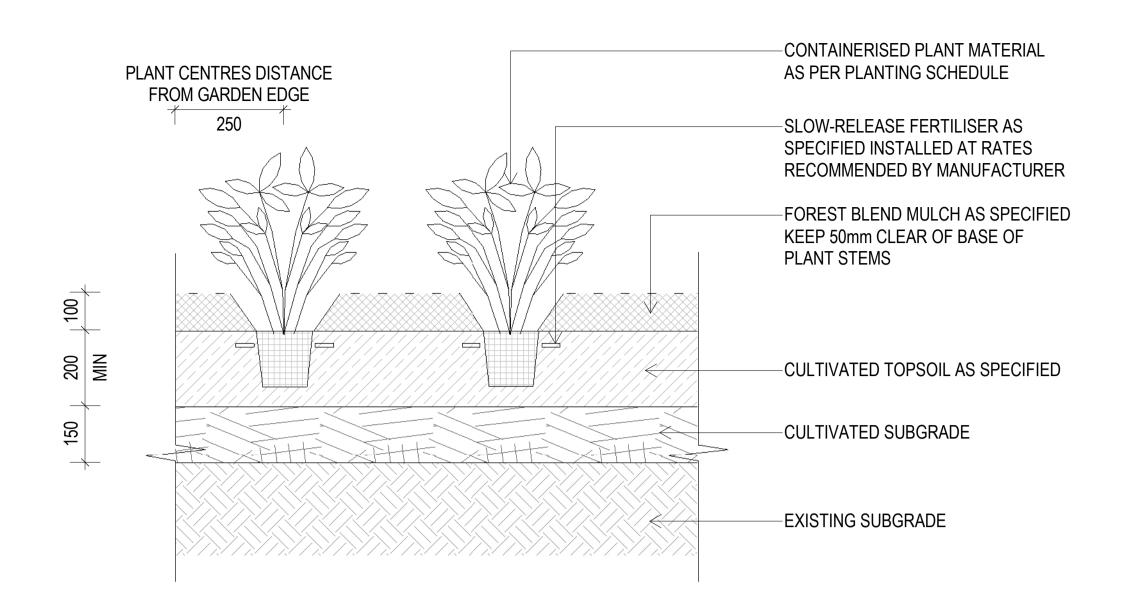


PLANTING NOTES:

- WHERE MORE THAN ONE SPECIES ARE NOMINATED FOR A PLANTING ZONE, GROUP SPECIES IN NUMBERS OF 3'S, 5'S + 9'S • REFER TO PLANTING PLANS AND PLANTING SCHEDULES FOR PLANT NUMBERS AND LOCATIONS
- PLANTS TO BE INSTALLED IN A STAGGERED PATTERN
- DISTRIBUTE PLANTS EVENLY OVER PLANTING AREA

• DO NOT PLANT IN ROWS UNLESS INDICATED

PLAN VIEW OF STAGGERED PATTERN:

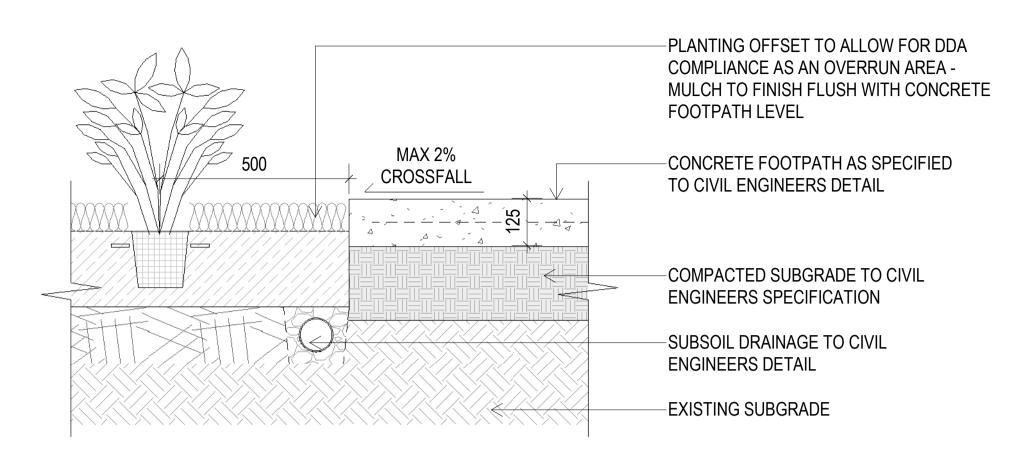

MASS PLANTING - TYPICAL GENERAL GARDEN BED PROFILE

SCALE 1:10

PLANTING DETAIL - TYPICAL LAYOUT PLAN

GARDEN BED TO CONCRETE PAVEMENT - TYPICAL INTERFACE DETAIL

-PADDING

STEEL PLATES OR EQUIVALENT WITH OR

WITHOUT MULCH

BRANCH

PROTECTION

SCALE 1:10

SIGNS SIGNS IDENTIFYING THE TPZ SHOULD BE PLACED AROUDN THE EDGE OF THE TPZ AND BE VISIBLE FROM WITHIN THE DVELOPMENT SITE. 1.8 M

LEGEND

LZ TW 21.06.2024

03.07.2024

11.09.2024

LZ TW

LZ TW

- 1. CHAIN WIRE MESH PANELS WITH SHADE CLOTH (IF REQUIRED) ATTACHED, HELD IN PLACE WITH CONCRETE FEET.
- 2. ALTERNATIVE PLYWOOD OR WOODEN PALING FENCE PANELS. THIS FENCING MATERIAL ALSO PREVENTS BUILDING MATERIALS OR SOIL ENTERING THE TPZ
- 3. MULCH INSTALLATION ACROSS SURFACE OF TPZ (AT THE DISCRETION OF THE PROJECT ARBORIST). NO EXCAVATION, CONSTRUCTION ACTIVITY, GRADE CHANGES, SURFACE TREATMENT OR STORAGE OF MATERIALS OF ANY KIND IS PERMITTED WITHIN THE TPZ.
- 4. BRACING IS PERMISSIBLE WITHIN THE TPZ. INSTALLATION OF SUPPORTS SHOULD AVOID DAMAGING ROOTS.

ALL TREE WORKS TO COMPLY WITH AS 4970 PROTECTION OF TREES ON DEVELOPMENT SITES.

TYPICAL DETAIL - TREE PROTECTION ZONE SCALE: NTS [REFERENCED FROM AS 4970-2009]

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CUMBERLAND CITY COUNCIL



ABN: 65 112 807 931

GUILDFORD POOL LOT 21, DP 1018330, 1 TAMPLIN ROAD, GUILDFORD

DRAWING TITLE **SOFTWORKS DETAILS 1**

GEOTEXTILE MEMBRANE

UNDERNEATH MULCH OR

AGGREGATE

- PADDING

TRUNK PROTECTION

[BATTENS STRAPPED TOGETHER]

-100MM OF MULCH

-RUMBLE BOARDS STRAPPED OVER

MULCH OR AGGREGATE LAYER

ISSUE 11/09/2024 11:26:56 AM SCALE @ A1 SCALE @ A3 As indicated As indicative PROJECT No STAGE REVISION LD- 5001

TYPICAL TREE TRUNK, BRANCH AND GROUND PROTECTION SCALE:NTS [REFERENCED FROM AS 4970-2009]


PROJECT Gadigal Country Level 5, 111-117 Devonshire Street Surry Hills, NSW 2010 **MODERNISATION PROJECT** T +61 2 8396 9500 syd@modedesign.com.au


1 FROZEN LANDSCAPE SET

DEVELOPMENT APPLICATION


REVISED DEVELOPMENT APPLICATION

DESCRIPTION

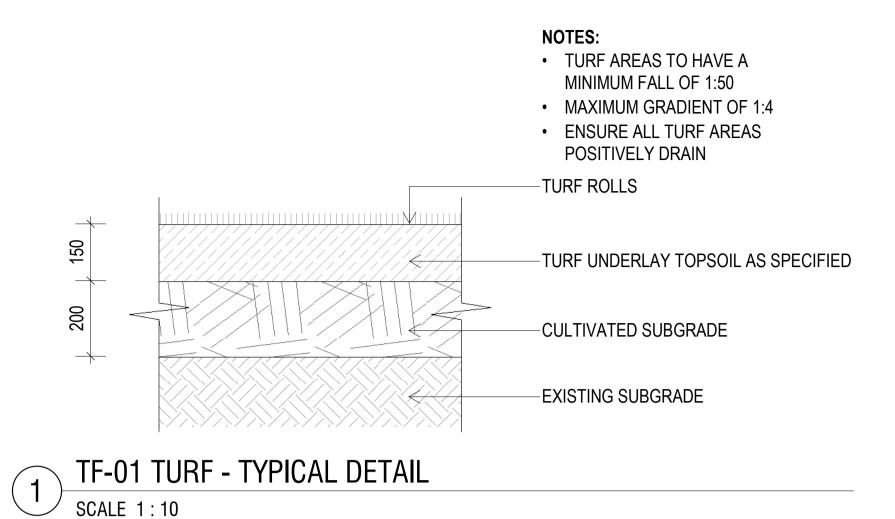


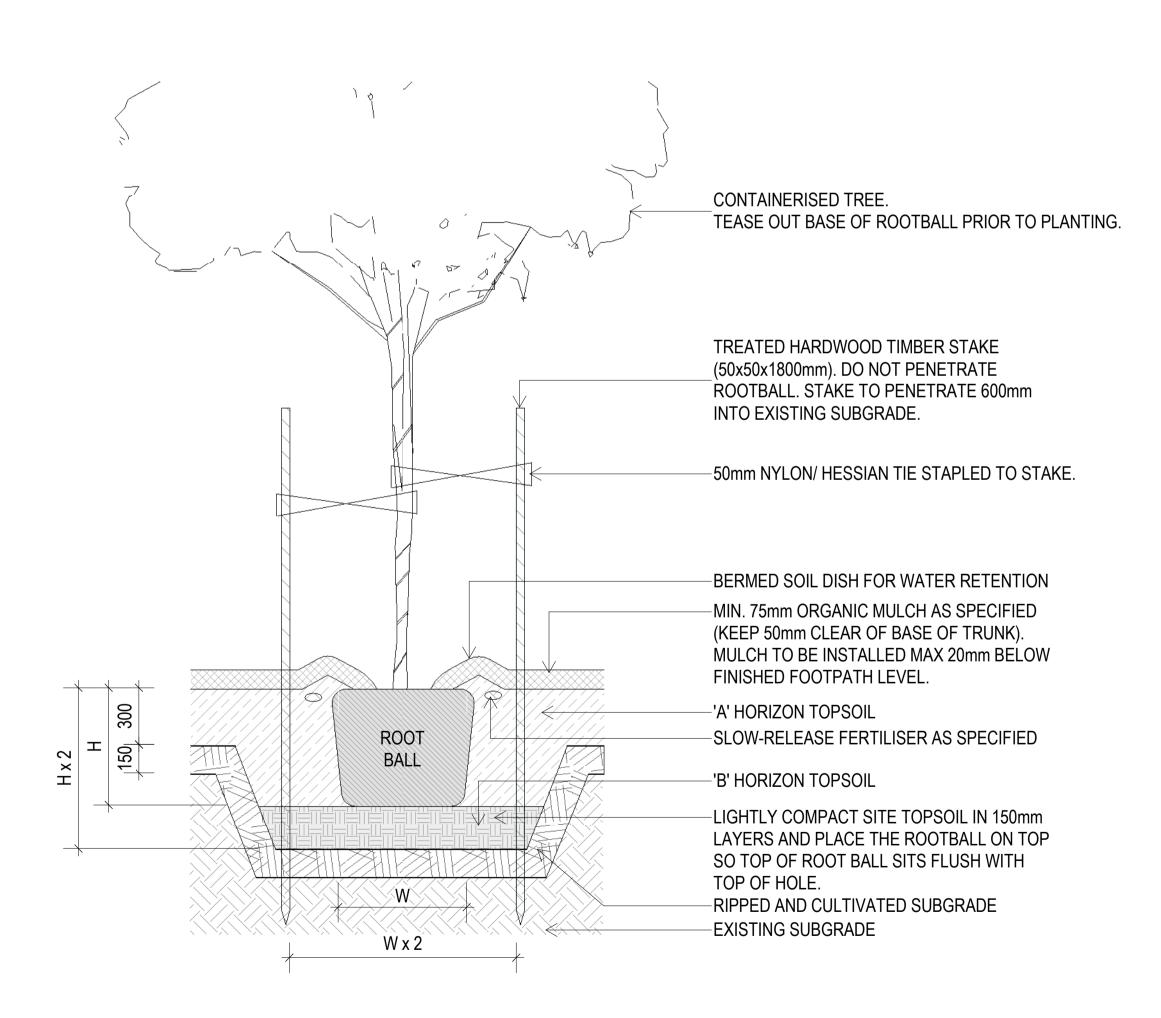

ADVANCED TREE TO GARDEN BEDS - TYPICAL PLANTING DETAIL SCALE 1:20

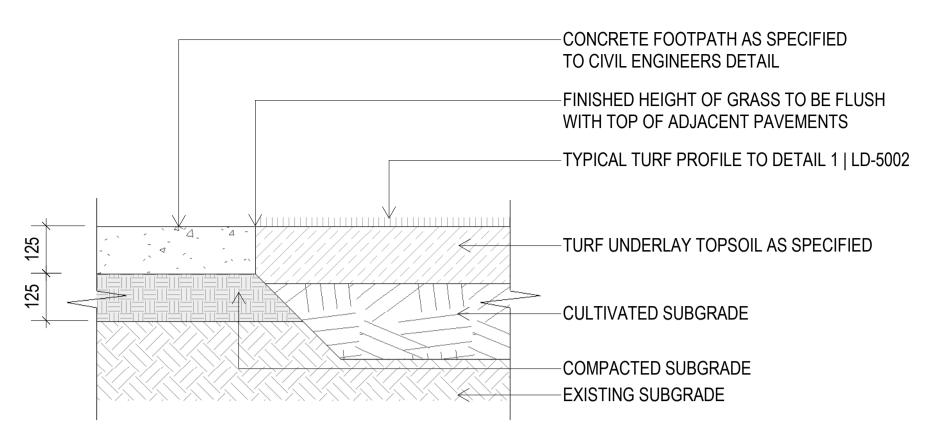

TURF TO CONCRETE - TYPICAL INTERFACE DETAIL

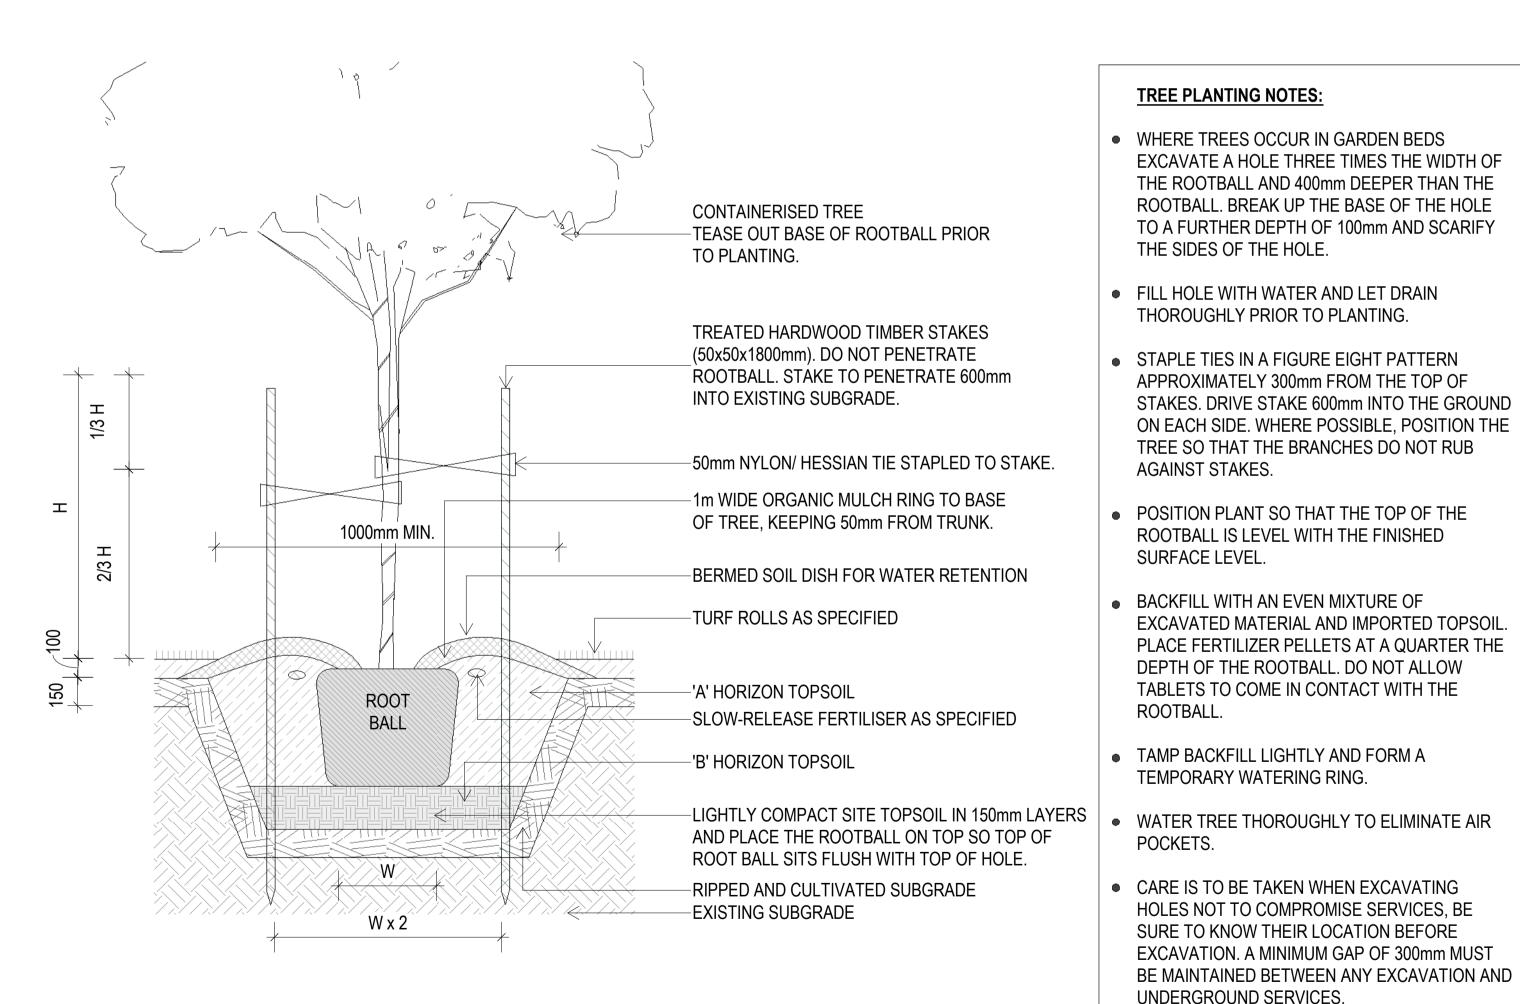

ADVANCED TREE TO TURF - TYPICAL PLANTING DETAIL

REV	DESCRIPTION	AUTH	CHK	DATE
1	FROZEN LANDSCAPE SET	LZ	TW	21.06.2024
2	DEVELOPMENT APPLICATION	LZ	TW	03.07.2024
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STATUS DEVELOPMENT **APPLICATION**

CUMBERLAND CITY COUNCIL





PROJECT Gadigal Country Level 5, 111-117 Devonshire Street **GUILDFORD POOL** Surry Hills, NSW 2010 **MODERNISATION PROJECT** T +61 2 8396 9500 syd@modedesign.com.au LOT 21, DP 1018330, 1 TAMPLIN ROAD, GUILDFORD ABN: 65 112 807 931

DRAWING TITLE **SOFTWORKS DETAILS 2** ISSUE 11/09/2024 11:27:00 AM SCALE @ A3 SCALE @ A1 As indicated As indicative PROJECT No STAGE REVISION 23710 LD- 5002

ROOTBALL. BREAK UP THE BASE OF THE HOLE

AGAINST STAKES.

Document Set ID: 11236292 Version: 1, Version Date: 14/11/2024